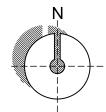
Arnold Close Recreation Ground SITE Gymnasium 86a 92 Path 113.4m Oak Street Community Road Centre 52 to 74 St Marv's Convent Alfred Green Close.... Dunchurch Ordnance Survey (c) Crown Copyright 2014. All rights reserved. Licence number 100022432

Land to rear of Dunchurch Road

Easting: 450065m Northing: 274663m ALL DIMENSIONS AND LEVELS TO BE CHECKED ON SITE AND ANY DISCREPANCIES TO BE REPORTED TO THE ARCHITECT BEFORE CONSTRUCTION.

DO NOT SCALE EXCEPT FOR PLANNING PURPOSES, THIS DRAWING TO BE READ IN CONJUNCTION WITH ALL RELEVANT DRAWINGS AND SPECIFICATIONS.

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E - Red line amended 22.07.16
D - General Amendments 19.07.16
C - Scale amended 02.07.14
B - Red outline removed 06.06.14

REVISION A - General Revisions 04.06.14



CLIENT

PROJECT RESIDENTIAL DEVELOPMENT
Land to rear of Dunchurch Road
Rugby
Warks
CV22 6DW

DWG TITLE EXISTING:

Location Plan

scale 1:1000 (A4)
Date May 2014

DWG NUMBER 307 - 01E






site section A-A scale 1:100





site section B-B scale 1:100

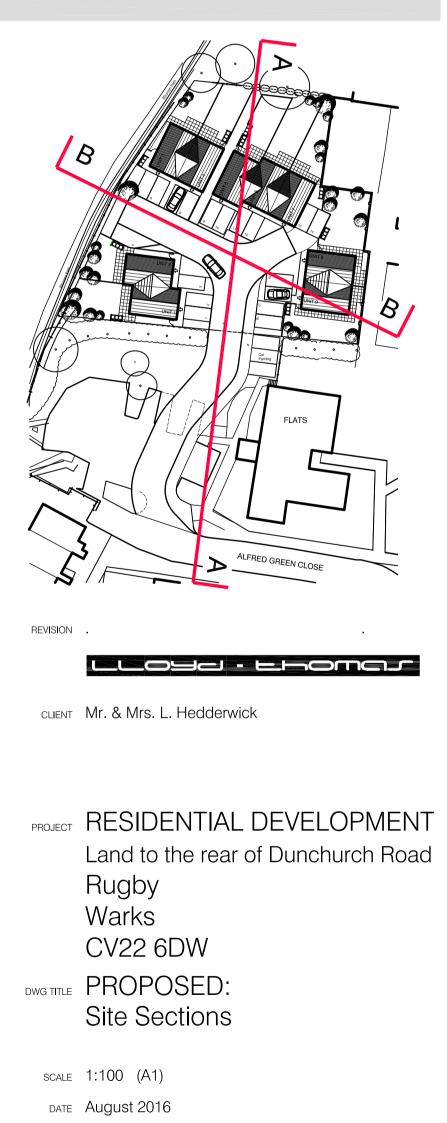

DWG NUMBER 307-08



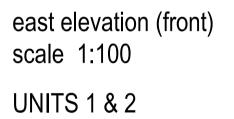


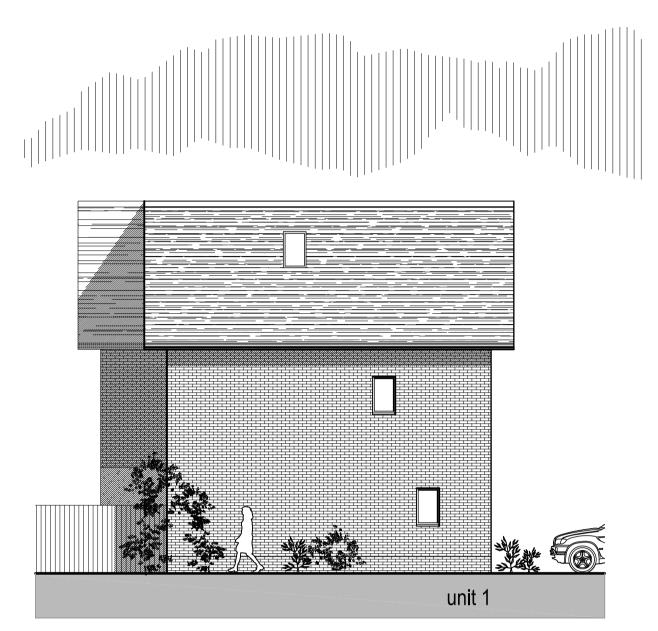

south elevation (side) scale 1:100




west elevation (rear) scale 1:100

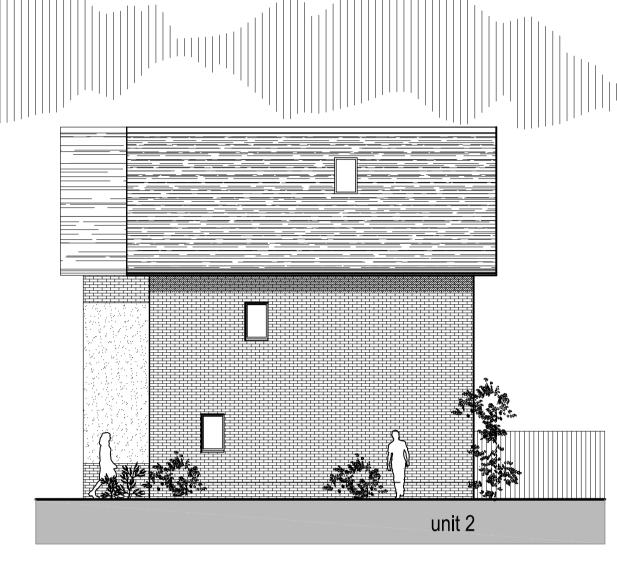

north elevation (side) scale 1:100




west elevation (front) scale 1:100 **UNITS 8 & 9**

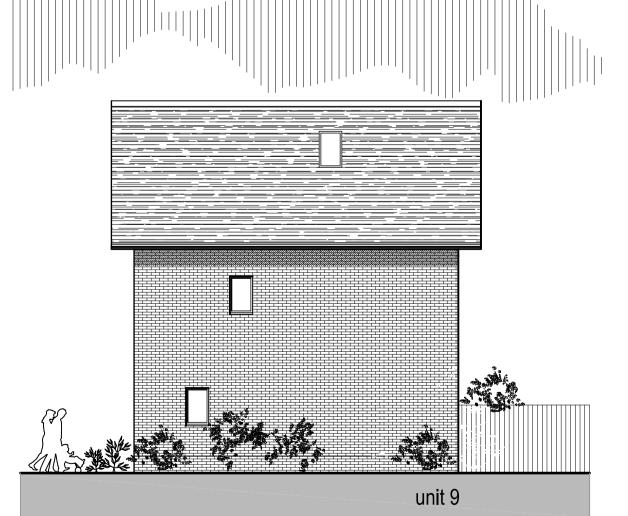


south elevation (side) scale 1:100



east elevation (rear) scale 1:100

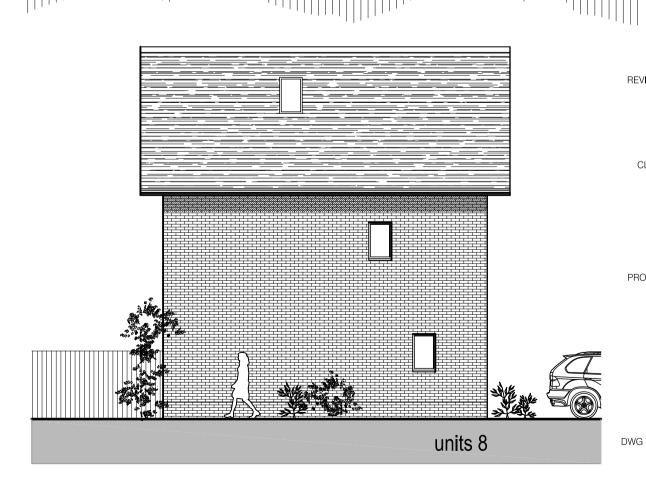


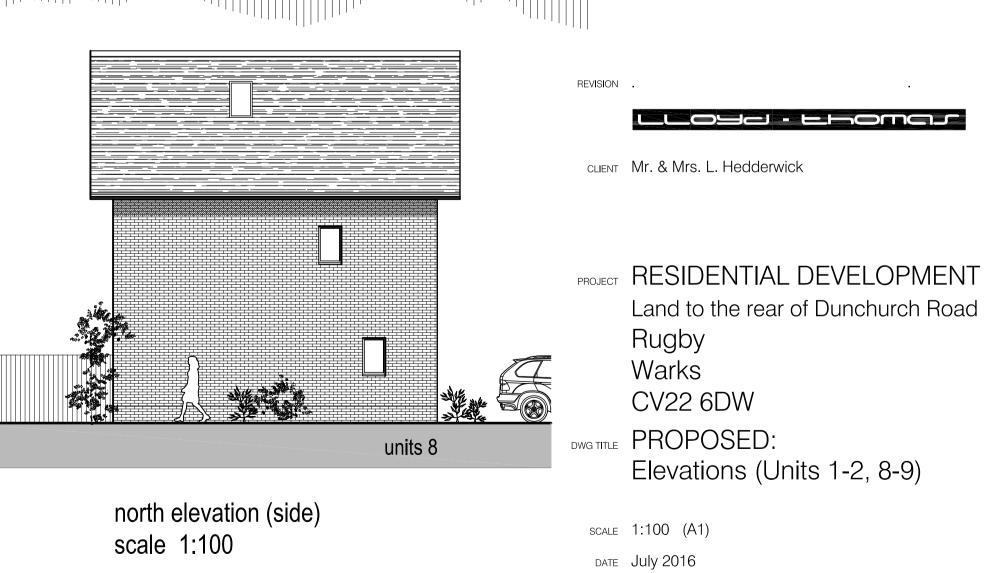


DWG NUMBER 307-06



south west elevation (front) scale 1:100

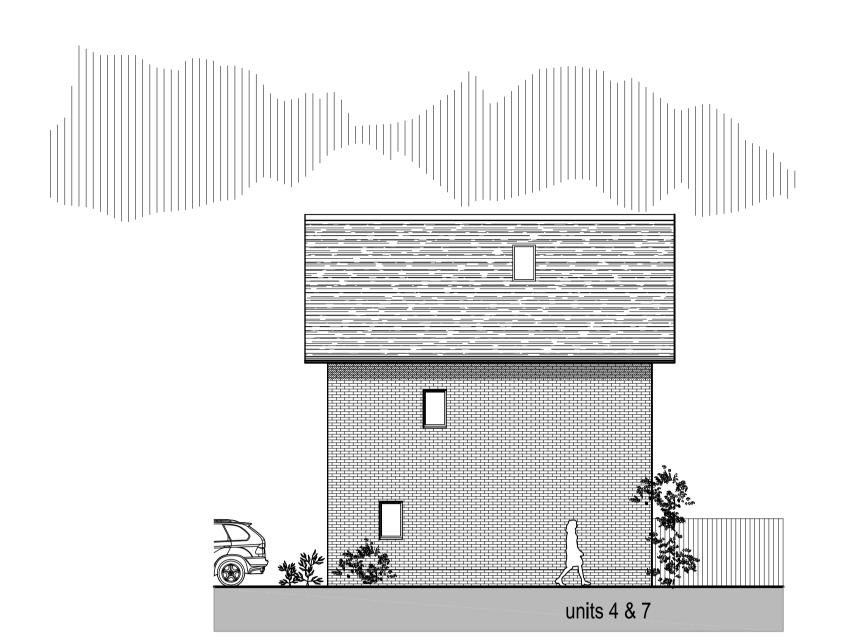

south east elevation (side) scale 1:100

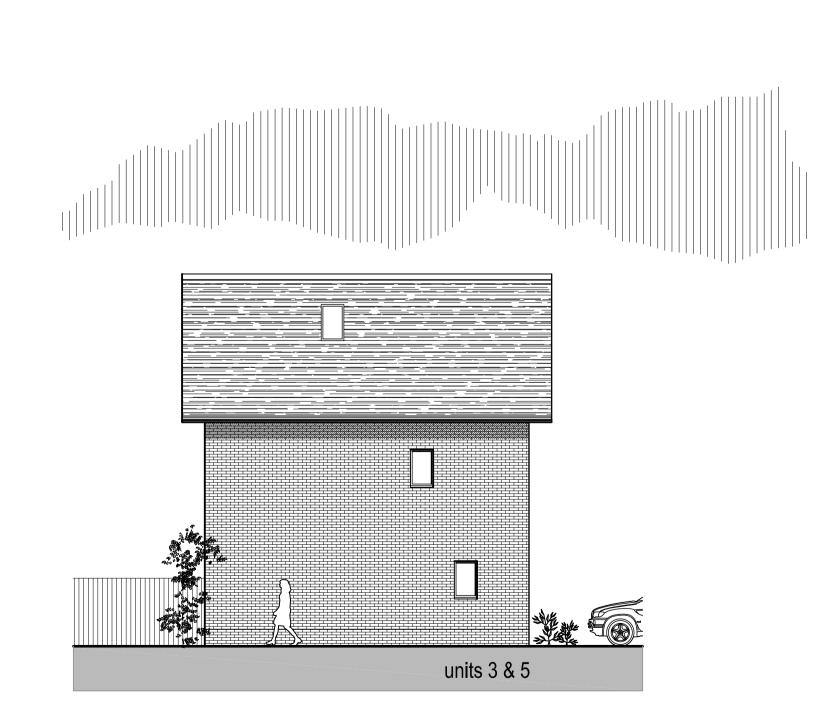

north west elevation (side) scale 1:100




north east elevation (rear) scale 1:100

ALL DIMENSIONS AND LEVELS TO BE CHECKED ON SITE AND ANY DISCREPANCIES TO BE REPORTED TO THE ARCHITECT BEFORE CONSTRUCTION.

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CLIENT Mr. & Mrs. L. Hedderwick

RESIDENTIAL DEVELOPMENT

Land to the rear of Dunchurch Road
Rugby
Warks
CV22 6DW

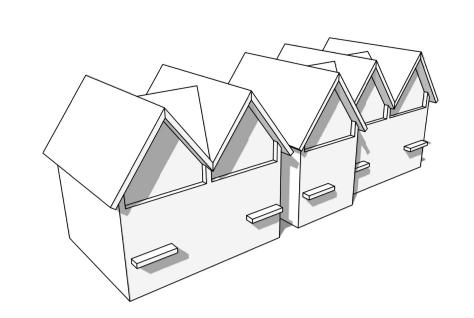DWG TITLE
PROPOSED:

Elevations (Units 3-7)

SCALE 1:100 (A1)

DATE July 2016

DWG NUMBER 307-05

MIX/ BOTANICAL NAME	COMMON NAME	STOCK	SPECIFICATION	DENSITY			
T1 Quercus robur fastigiata 'Koster' T2. Carpinus betulus 'Frans Fontaine'	Fastigiate Oak Fastigiate Hornbem	Standard (heavy) 350- 425cm) RB	Trees to be pit planted. Minimum pit size 900x900x750mm. Excavate tree pits with slightly raised centre. The trees will be	Single specimens			
T3 Acer campestre 'Elegant' T4. Sorbus aucuparia 'Joseph Rock'	Field Maple Rowan 'Joseph Rock'		planted to the same depth as they were in the nursery. Tree pits to be filled with 1:3 mixture of compost and topsoil. Topsoil to contain			A B 4 E	NIDED
T5. Prunus 'Pandora'	Flowering Cherry 'Pandora'		peat free organic matter and tree fertiliser to be incorporated into each pit. Stake with short treble stakes and adjustable rubber ties. Height of stakes: cut to approximately one third of the tree height above ground level. Tying: secure tree firmly but not rigidly to stake			AIVIE	INDED _N
T6. Crataegus laevigata 'Paul's Scarlet'	Midland Hawthorn	Standard (selected) girth					
T7. Malus 'Evereste' T8. Amelanchier lamarckii 'Robin Hill'	Flowering Crab Juneberry	10-12cm; 300-350cm; bare rooted	as they were in the nursery. Tree pits to be filled with 1:3 mixture of compost and topsoil. Topsoil to contain peat free organic matter				
			and tree fertiliser to be incorporated into each pit. Stake with short single stake and adjustable rubber tie. Height of stakes: cut to approximately one third of the tree height above ground level. Tying: secure tree firmly but not rigidly to stake with ties within 25mm of top of stake.			1.8m Fence	
H1. Hedge mix A Crataegus monogyna*	Hawthorn	All woody 1+1 bare- rooted 40-60cm whips	Prepared soil should be enriched with bulky organic matter at a rate of 4l per m ² to a depth of 30cm. Trees to be pit planted to the same	Double row diagonal spacing 45cm centres (5/linear m) Random mix of		Existing hedgerow	
Prunus spinosa* Corylus avellana*	Blackthorn	except Ilex C2L 40-60cm	depth they were grown in the nursery (to the soil line). Trees to be pit-planted, with sufficiently large pit to accommodate root system	species 70% C monogyna; 10% P spicata; 5% each other species	S2	restored 2no T7 S1 T2	
Rhamnus cathartica* Ilex aquifolium*	Purging Buckthorn Holly		without bending roots. Each tree to be staked with a 90cm bamboo cane and tied using a ring tie or similar suitable means of securing.		T4		
Cornus sanguinium* Acer Campestre*	Dogwood Field Maple		Hedge line mulched with a minimum of 50mm of sterile loose mulch bark chip. Bulbs planted in random groups up to 30cm from hedge		T5	SI	_S1
H2. Prunus 'Otto Luyken'	Dwarf Laurel	Bushy 30/40cm C3L	centre line at an average of 5 per linear m Prepared soil should be enriched with bulky organic matter at a rate	Double row planted 4 per linear m			
S1. Ornamental evergreen mix Viburnum tinus	Laurustinus	Bushy 40/60cm C5-7.5L	of 4l per m ² . Shrubs/herbaceous plants to be pit-planted, with sufficiently large pit to accommodate root system without bending	Mixed shrub and ground cover			—Т6
Hebe 'Red Edge' Hebe 'Pagei'	Shrubby Veronica Shrubby Veronica	Bushy 20/30cm C2L Bushy 20/30cm C3L	roots (minimum size of 150mm wider than roots when fully spread and 200mm deep). Planting bed to be mulched with biodegradable	planting			
Skimmia japonica 'Rubella'	Skimmia 'Rubella'	Bushy 30/40cm C3L	weed suppressant matting with 50mm loose bark ornamental fine				
Prunus 'Otto Luyken' Euonymus 'Emerald Gaiety' Euonymus 'Emerald and Gold'	Dwarf Laurel Fortune's Spindle	Bushy 30/40cm C3L Bushy 20/30cm C2L	grade mulch S2 deciduous mix planted near hedges to reduce impact of light		85 m H1 New mixed native hedgerow		
Euonymus 'Emerald and Gold' Escallonia 'Crimson Spire' Osmanthus beterophyllus 'Purpureus''	Fortune's Spindle Escallonia 'Crimson Spire'	Bushy 20/30cm C2L Bushy 40/60cm C3L	competition from shrub planting on hedge species. S1 ornamental				-2no T7
Osmanthus heterophyllus 'Purpureus'' S2 Taxus baccata 'Reptandens' Corpus alba 'Kosselringii'	Holly Olive Creeping Yew Purple stemmed Dogwood	Bushy 30/40cm C3L Bushy 20/30cm C3L Bushy 40/60cm C2L	species mix used in areas away from native hedge. Planting choice and arrangement to provide optimal growing conditions and amenity value	Mixed shrub and ground cover		AAAA NA AAAAA	
Cornus alba 'Kesselringii' Chaenomeles japonica	Japanese Quince	Bushy 20/30cm C2L	afferity value	planting			
Ajuga reptans 'Atropurpurea' Geranium macrorrhizum Hygginthoides pon scripta	Bugle Hardy Geranium	C1L C1L					
Hyacinthoides non-scripta Primula vulgaris G1 Euonymus fortune 'Emerald Gaeity'	English Bluebell Primrose Fortune's Spindle	9/+ top size C1L Bushy 20/30cm C2L		Ground cover planting	S2	Т3	S1
Narcissus pseudonarcissus	Wild Daffodil	Bulb 7/+ top size	Laid to industry standard on proposed topsail. Turf must most the	5 per m2 random naturalization	G1		T3
L1. Fine grade turf laid in all front garden areas	Fine grade turf	1m rolls	Laid to industry standard on prepared topsoil. Turf must meet the Turfgrass Grower's Association (TGA) Quality Standards for	1 per square m			
L2 Amenity Grade Turf laid in all rear garden and amenity spaces	Amenity Grade Turf	7	Cultivated Turf for the supply and laying of turf. The turf soil should be of a sandy loam nature with no stones. The grass will be dense,				S1
garden and amenity spaces			of uniform green colour, free of broadleaved weeds and not visibly affected by pest or disease. Existing vegetation and stones should			Т6	
			be removed and a light tilth prepared. Turf to be laid within 24 hours of receipt. Turfing shall comply with BS 3969 and be carried				
			out when the weather and soil conditions are suitable. Turfing should not be carried out in exceptionally dry or frosty weather or				77
			when the ground is waterlogged. Allowance should be made to keep the turf watered during dry periods encountered throughout the		3no T1		
			establishment period. in grass. Coverage: planted areas and ornamental trees and shrubs. Finish				4
opportunity. *Denotes provenance require		e peat-free composts, mulches	s and soil conditioners. Any losses within the first five years to be replaced	like for like at the first seasonal	T3 S2	T8	
SCALE PAPER SIZE		D.	KEY		G1 G1		
1:125 A1	KEY		KEY		T4		
	1.8 m	n Fence	Specin	en Trees			H2
DATE DRAWN BY							
13/09/2016 Danielle Jeynes	Habib 1)inte	oat 001 (type ergrated bat			T3 S2		
Dwg No	box	+	Shrubs		T5		ğ
Dwg. No. 249 Rev 1	Schwe	egler crete 32mm			S2 S2		vel tra
	nest b			1		H2	Gra
			Dwarf	/			
DRAWING	Matur	re existing		T4 —	G1		H2
Landscape Scheme	trees				T6 DDD	S1 S2	
DDO IFOT	-		Native	nedge		S2 S2	
PROJECT Residential development Land to the rear of Dunchurch					H1		
Road Rugby Warks CV22 6DW							T5——S2
CLIENT				pundcover	T3 T5	T2 G1 T6 T3 T7	
Mr. & Mrs. L. Hedderwick					T3 T4 T3		
DJOGS							
Landscape Architect			Ground	cover			
Danielle Jeynes M.A info@djogs.co.uk					Existing vegetation removed and new turf laid	Existing vegetation removed and new turf laid	14m H1 New mixed native hedgerow
01922 442665				, time			
	NOTE		Amenit	y turr			
	Bat bo	ooxes intergrated into sou g walls, minimum 4.5m f	ith/east				
	groun	nd.	Restor	ed grass			
	facing	boxes erected on north-eg side of tree, minimum	ast				
	4.5m	from ground.					

