

REVISION	DATE	DESCRIPTION
	11.11.16	Planning Issue.

Key

Site Boundary

PLANNING ISSUE

Location Plan



- 31, Blackfriars Road, Salford, Manchester M3 7AQ

- t 44(0)161 832 3242 f 44(0)161 832 3623 e info@omiarchitects.com w www.omiarchitects.com

PROJECT	Lower Hill	ower Hillmorton Road, Rugby					
DRAWING	Location	Location Plan					
DATE	Mar '16	DRAWN BY	JM	SCALE	1:1000@A3		
JOB NO.	1366	DWG.NO.	1 0001				





11.11.16 Planning Issue.

10.03.17 Planning Amendments

Proposed Boundary Treatments Plan 1:500 @ A1 / 1:1000 @ A3

Key:

2.1m high close boarded fence

1.8m high close boarded fence

1.5m high close boarded fence with existing hedge retained

existing hedge retained1.0m high railings with new planted hedge



Existing trees to be retained



Proposed trees to be planted



PLANNING ISSUE

Proposed Site Plan 1:250 @ A1 / 1:500 @ A3

OMÍ ARCHITECTS


31, Blackfriars Road, Salford, Manchester M3 7AQ † 44(0)161 832 3242 f 44(0)161 832 3623

w www.omic	architects.com
ROJECT Lower Hillmorton Road, Rugby	,

Proposed Site Plan

Mar '16 DRAWN BY JM SCALE 1:250@A1

1366 DWG.NO. L 1000A

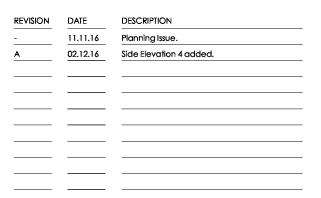






Front Elevation 1 1:200


Side Elevation 2 1:200



Rear Elevation 3

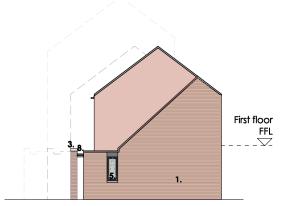

Side Elevation 4

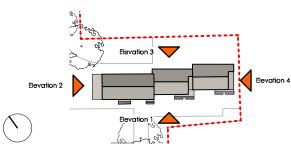

o Denotes obscure glazing

Materials Key:

- 1. Facing Brick Type 1 (to Local Authority Approval)
- 2. Facing Brick Type 2 (to Local Authority Approval) 3. Reconstituted Wet Cast Stone Cills & Copings
- 4. Interlocking Concrete Slate Roof Tiles
- Composite Aluminium & Timber Windows
- Secured by Design Accredited Doorset & Glazed Side Panel) Galvanised & Painted Steel Lintel
- Dark Grey Single-Ply Membrane to Entrance Porch Roof
- 9. Dark Grey uPVC Rainwater Goods
 10. Decorative Brickwork Detail

PLANNING ISSUE

Proposed 2/3 Storey Apartment Elevations

1:200

DATE

JOB NO.

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PROJECT Lower Hillmorton Road, Rugby

Proposed 2/3 Storey Apartment Elevations DRAWING NOV '16 JM SCALE 1:200 @ A3 DRAWN BY DWG.NO. 1366 L 1603 A

Proposed Block Plan with Key






Front Elevation 1 1:200

Side Elevation 3 1:200



Rear Elevation 2

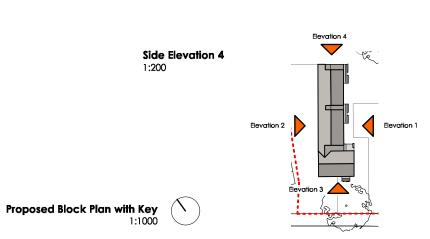

First floor

FFL

o Denotes obscure glazing

Materials Key:

REVISION

DATE

11.11.16

02.12.16

DESCRIPTION

Planning Issue.

Side Elevation added.

- 1. Facing Brick Type 1 (to Local Authority Approval)
- Facing Brick Type 2 (to Local Authority Approval)
 Reconstituted Wet Cast Stone Cills & Copings
- 4. Interlocking Concrete Slate Roof Tiles
- 5. Composite Aluminium & Timber Windows 6. Secured by Design Accredited Doorset & Glazed Side Panel)
- 7. Galvanised & Painted Steel Lintel
- 8. Dark Grey Single-Ply Membrane to Entrance Porch Roof
- 9. Dark Grey uPVC Rainwater Goods
 10. Decorative Brickwork Detail

PLANNING ISSUE

Proposed 2/3 Storey Apartment Elevations

1:200

JOB NO.

1366

OMI ARCHITECTS

1:200 @ A3

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L 1604 A

PROJECT Lower Hillmorton Road, Rugby DRAWING Proposed 2 Storey Apartment Elevations DATE JM SCALE Mar'16 DRAWN BY


DWG.NO.






Front Elevation



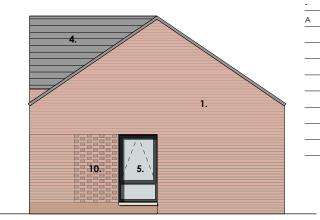

Side Elevation - Plot 14

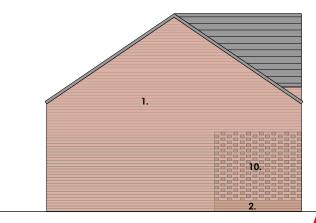

Side Elevation - Plot 13

AMENDED

DESCRIPTION

Planning Issue.

Planning Amendments

11.11.16

10.03.17

Received 09/03/2017

Materials Key:

- 1. Facing Brick Type 1 (to Local Authority Approval)
- 2. Facing Brick Type 2 (to Local Authority Approval)
- 3. Reconstituted Wet Cast Stone Cills & Copings
- 4. Interlocking Concrete Slate Roof Tiles
- 5. Composite Aluminium & Timber Windows
- 6. Secured by Design Accredited Doorset & Glazed Side Panel)
- 7. Galvanised & Painted Steel Lintel
- 8. Dark Grey Single-Ply Membrane to Entrance Porch Roof
- 9. Dark Grey uPVC Rainwater Goods
- 10. Decorative Brickwork Detail

PLANNING ISSUE

Proposed 1B Bungalow

Gross Internal Floor Area 53.1 sq.m 1:100 @ A3

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PROJECT Lower Hillmorton Road, Rugby Proposed 1B Bungalow Plans & Elevations


Apr '16 DRAWN BY 1366 DWG.NO.

DATE

JOB NO.

MI SCALE L 1052

1:100 @ A3

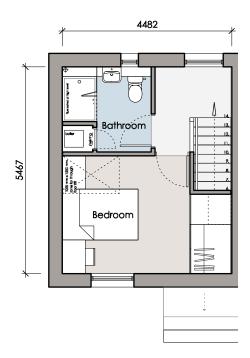

First Floor Plan

Gross Internal Floor Area 24.2 sq.m



Ground Floor Plan

Gross Internal Floor Area 25.9 sq.m




Rear Elevation 1:100




Received 09/03/2017

REVISION	DATE	DESCRIPTION
	11.11.16	Planning Issue.
Α	02.12.16	Side Elevations added.
В	10.03.17	Planning Amendments

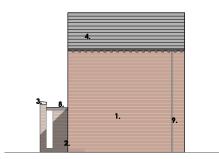

Side Elevation

1:200

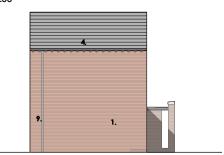


Side Elevation 1:200

Materials Key:

- Facing Brick Type 1 (to Local Authority Approval)
 Facing Brick Type 2 (to Local Authority Approval)
 Reconstituted Wet Cast Stone Cills & Copings

- Interlocking Concrete Slate Roof Tiles
 Composite Aluminium & Timber Windows
- 6. Secured by Design Accredited Doorset & Glazed Side Panel)
- 7. Galvanised & Painted Steel Lintel
- 8. Dark Grey Single-Ply Membrane to Entrance Porch Roof
 9. Dark Grey uPVC Rainwater Goods

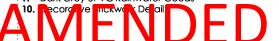

PLANNING ISSUE

Proposed 1B Townhouse

Gross Internal Floor Area 50.1 sq.m 1:100 @ A3

OMI ARCHITECTS

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PROJECT	Lower Hill	morton Road	i, Rugby			
DRAWING	Proposed	Proposed 1B Townhouse Plans & Elevations				
DATE	Apr'16	DRAWN BY	MI	SCALE	1:100 @ A3	
JOB NO.	1366	DWG.NO.	L 105	1B		




Rear Elevation



Side Elevation



Front Elevation

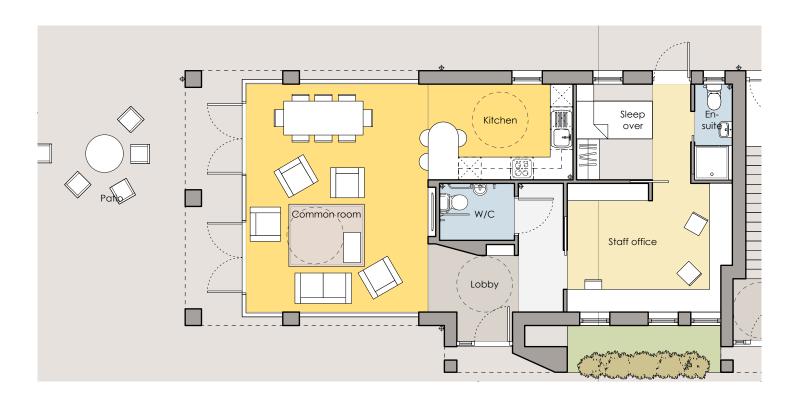

Ground Floor Plan

1:100

Materials Key:

1. Facing Brick - Type 1 (to Local Authority Approval)

DESCRIPTION

Planning Issue.

11.11.16

- 2. Facing Brick Type 2 (to Local Authority Approval) 3. Reconstituted Wet Cast Stone Cills & Copings
- 4. Interlocking Concrete Slate Roof Tiles
- 5. Composite Aluminium & Timber Windows
- 6. Secured by Design Accredited Doorset & Glazed Side Panel)
- 7. Galvanised & Painted Steel Lintel
- 8. Dark Grey Single-Ply Membrane to Entrance Porch Roof
- 9. Dark Grey uPVC Rainwater Goods
- 10. Decorative Brickwork Detail

PLANNING ISSUE

Proposed Common Room & Staff Office

1:100 @ A3

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PROJECT Lower Hillmorton Road, Rugby Proposed Common Room & Staff Office Plans & Elevations

DATE Apr '16 JOB NO. 1366

DRAWN BY DWG.NO.

MI L 1054


SCALE


1:100 @ A3








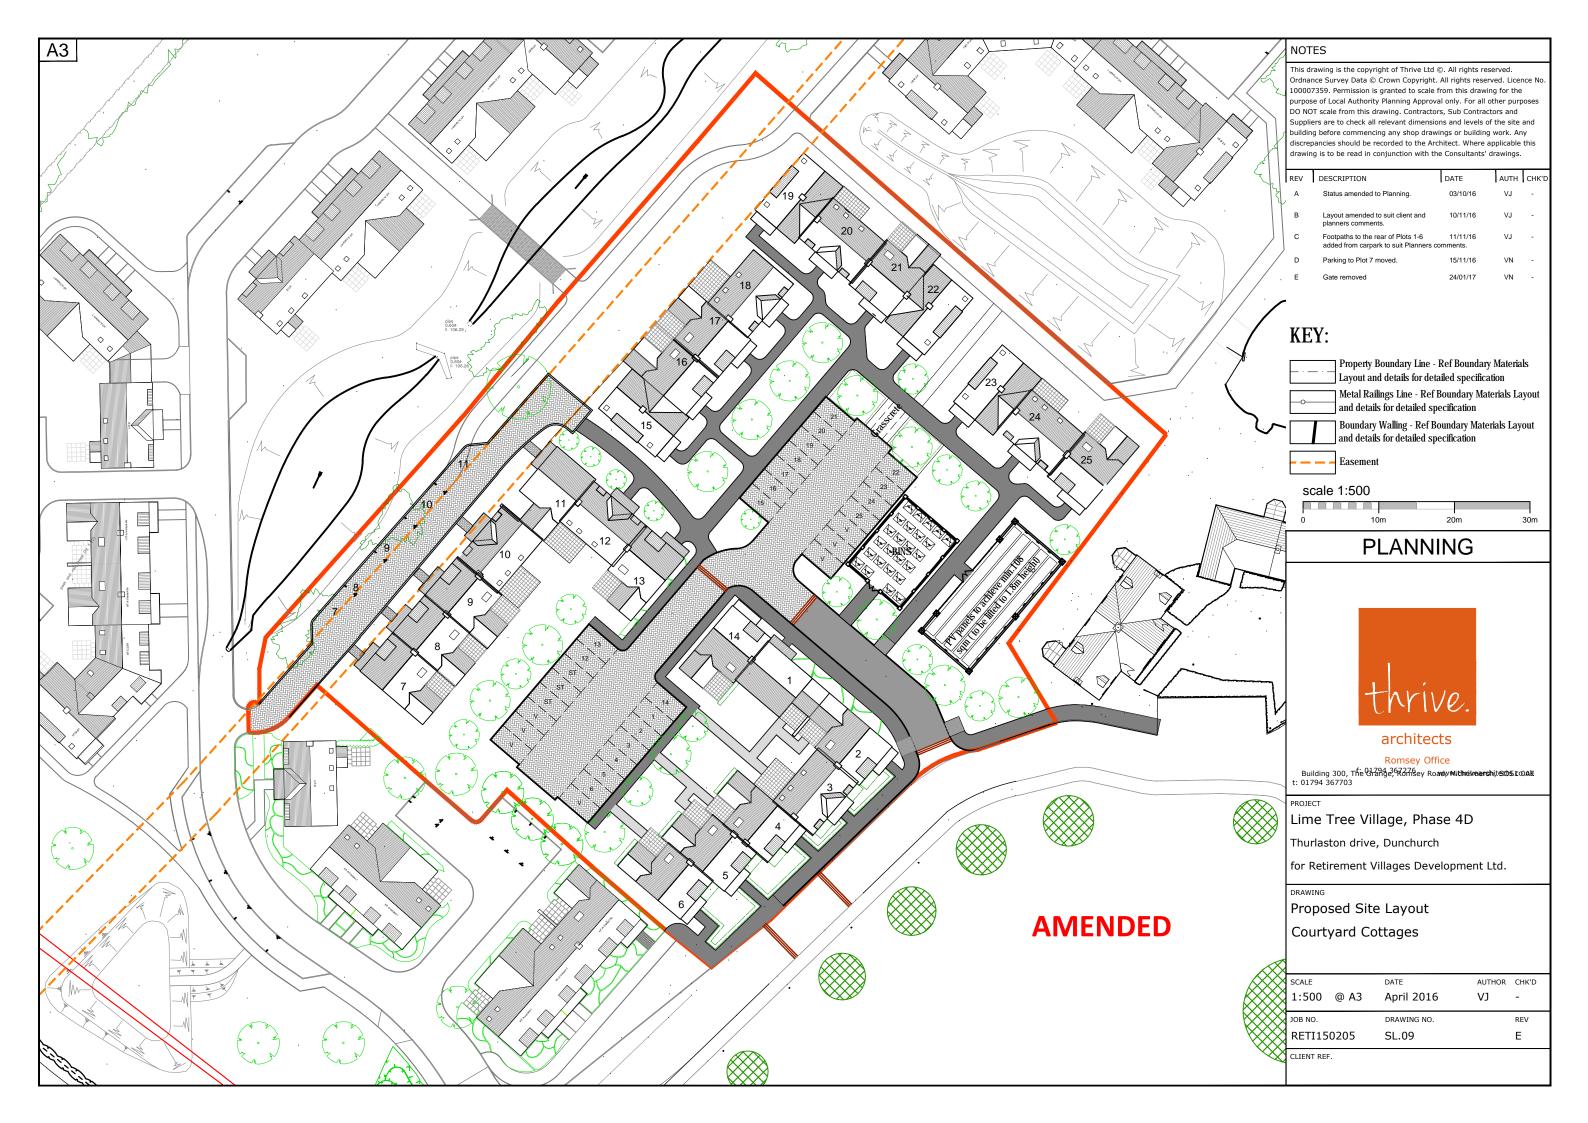


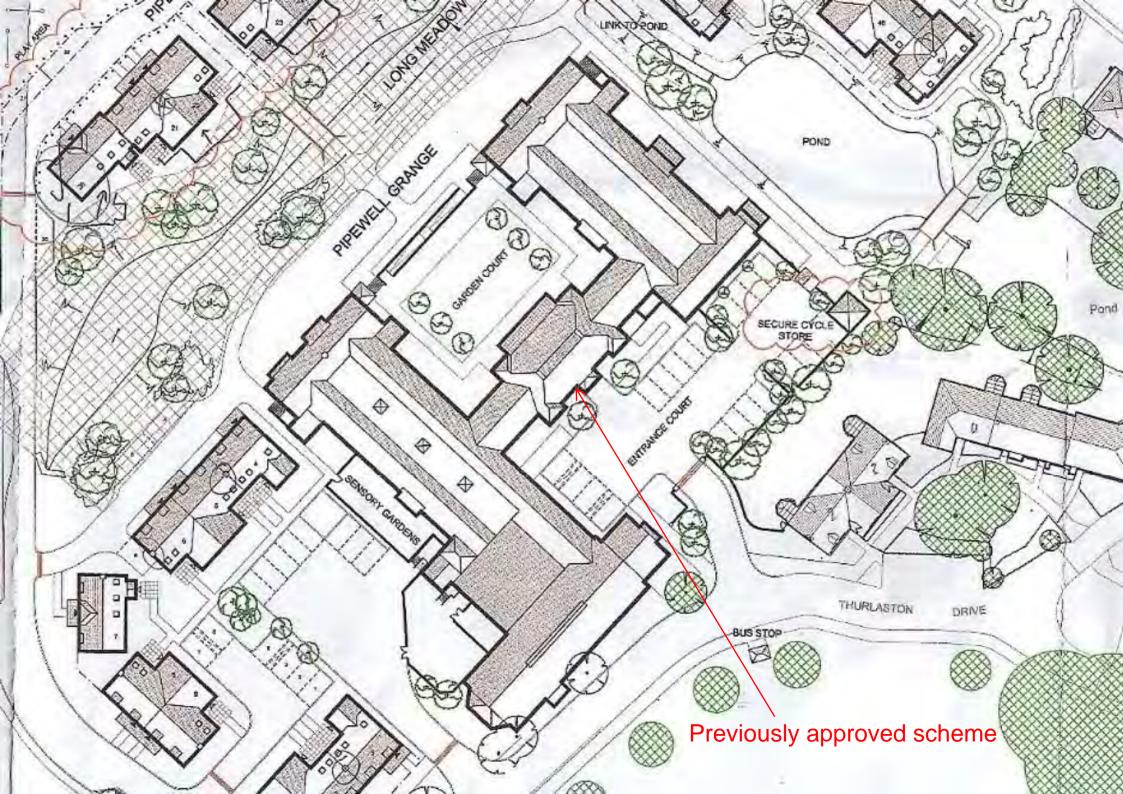




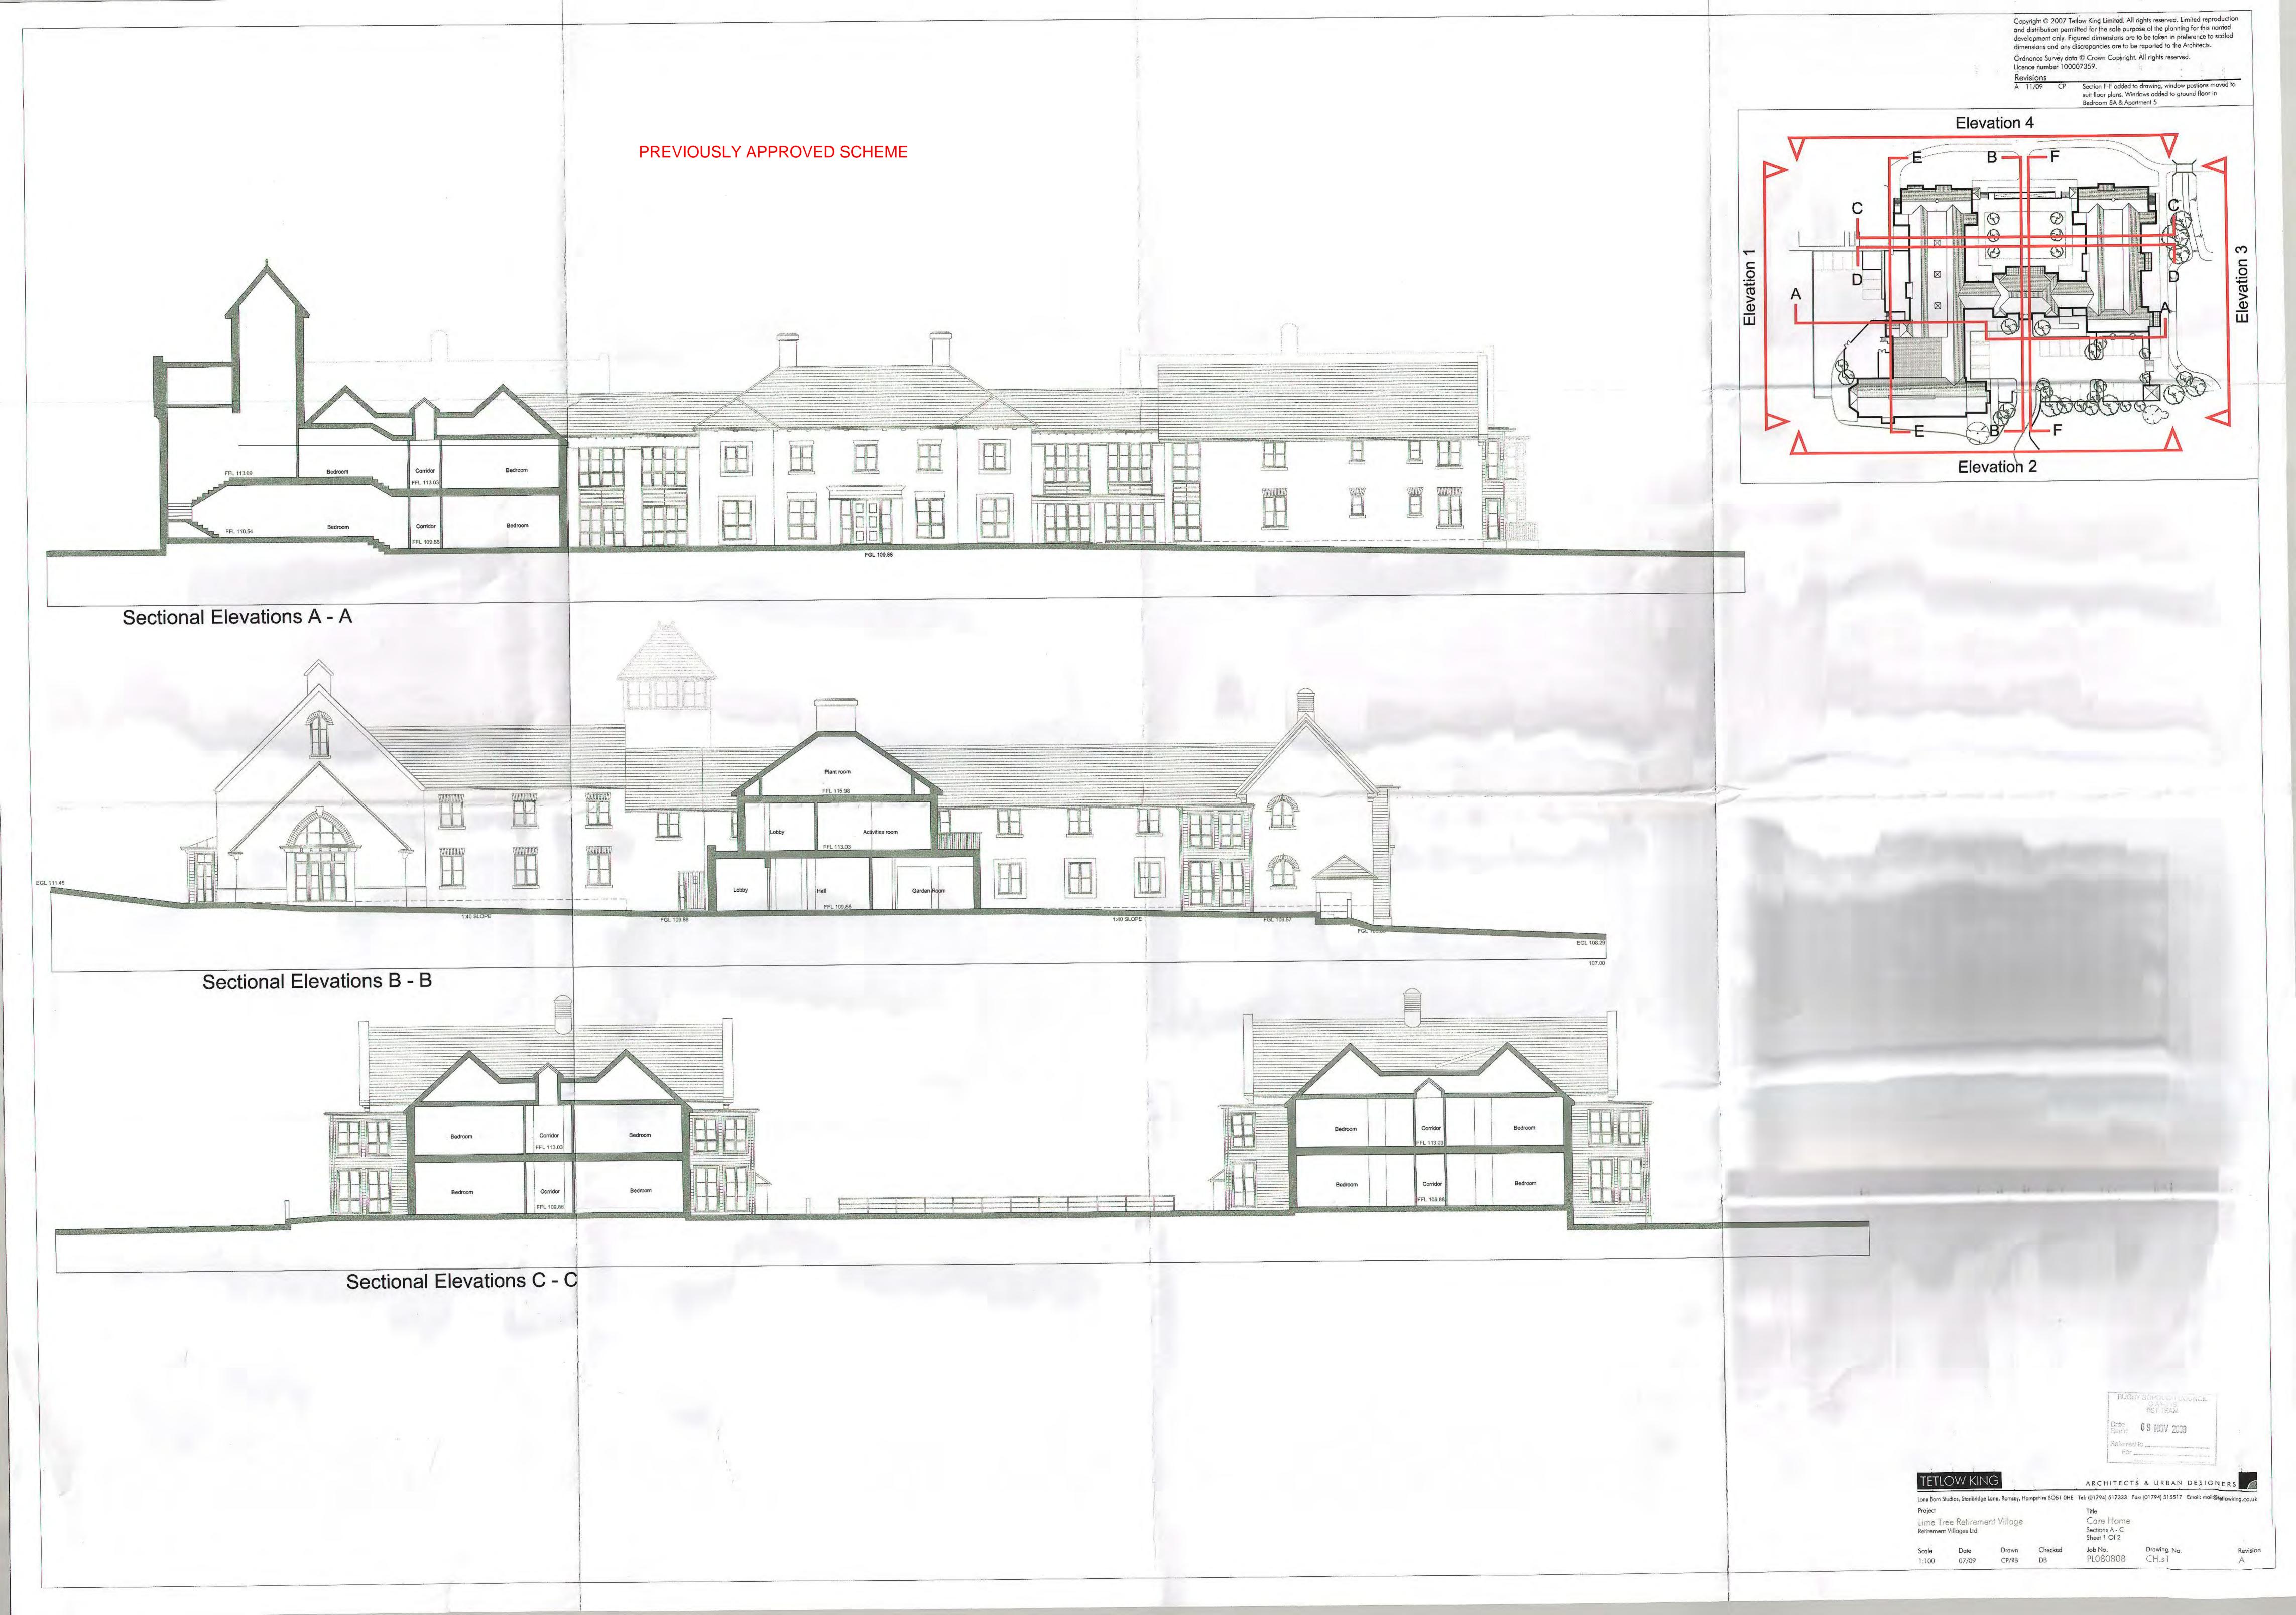




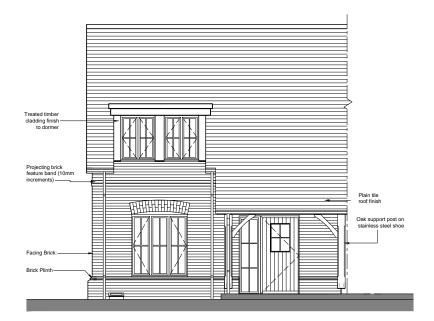

Front Elevation

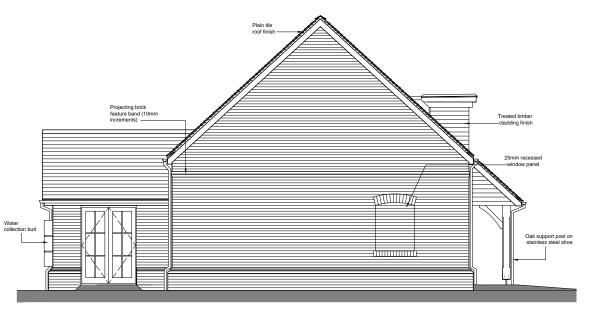

Side Elevation

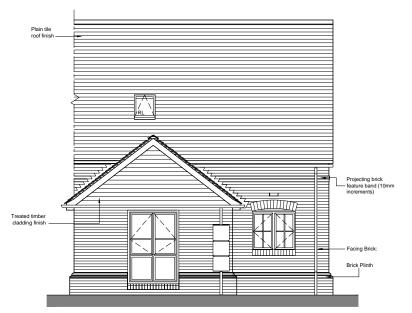

Rear Elevation

Example of Extra Care Cottages

Housetype[]	BEAU	Variation[]	Α
Bedrooms[2	Persons[]	4
Sq.ft[] finish[]	986	Sq.m[] finish[]	91.58

PLOT No. As Drawn - 04,05,06,07,08,09,13,14,16,17,21,25 Handed -

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consultants drawings.


REV DESCRIPTION

DATE AUTH



living/dining Store Shower room bedroom 1

Ground Floor Plan

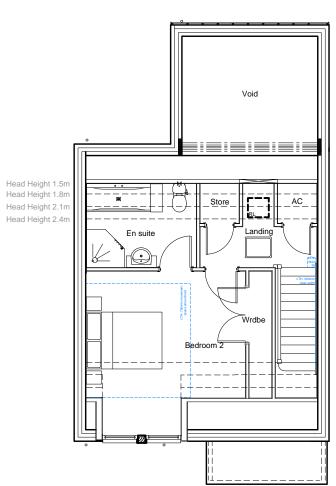

First Floor Plan

PLOT No.
As Drawn - 04,05,06,07,08,09,13,14,16,17,21,25
Handed -

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Consultants' drawings.

REV DESCRIPTION DATE AUTH CHI



PLANNING



Romsey Office Building 300, The Grange, Romsey Roaw MitheinearshitsเปรียบAk t: 01794 367703

PROJEC

Retirement Villages

Standard House Types

Reduced Area


DRAWI

Beaufort (Variation A)


Floor Plans

Ground and First Floors


SCALE		DATE	AUTHOR	CHK'D
1:100 @	A3	03/06/16	AM	VN
JOB NO.		DRAWING NO.		REV
-		HT.BEAU_A.p		
CLIENT REF.				
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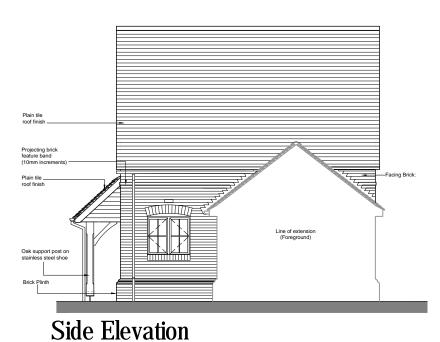


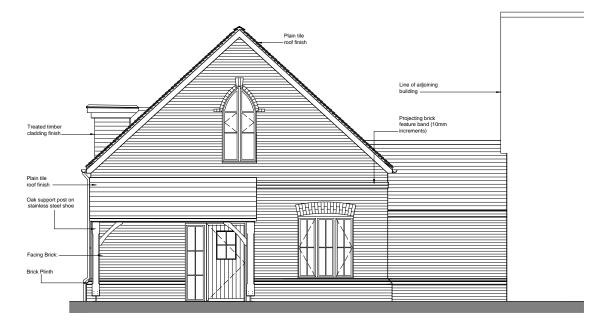
Front Elevation

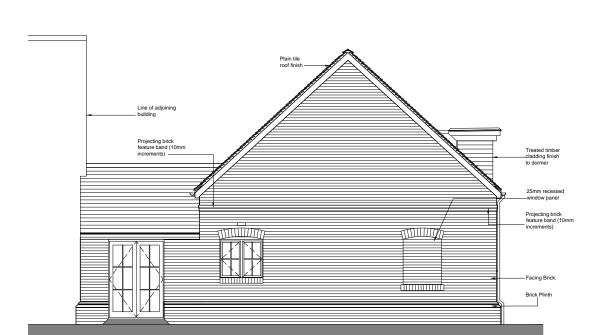

Side Elevation



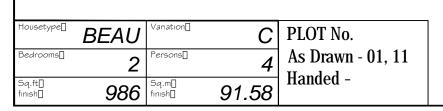

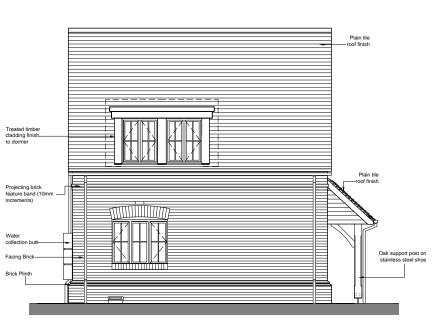

Side Elevation

Example of Extra Care Cottages

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REV DESCRIPTION DATE



PLANNING



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Building 300, The Grange Road Road Mithelmarshit SOS LOAK t: 01794 367703

PROJEC

Retirement Villages

Standard House Types

Reduced Area


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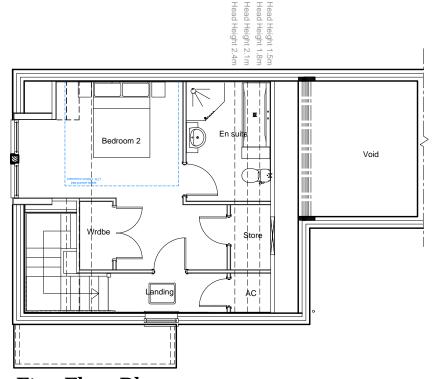
Beaufort (Variation C)

Elevations

Front, Side and Rear

SCALE	DATE	AUTHOR	CHK'D
1:100 @ A3	03/06/16	AM	VN
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First Floor Plan

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Romsey Office

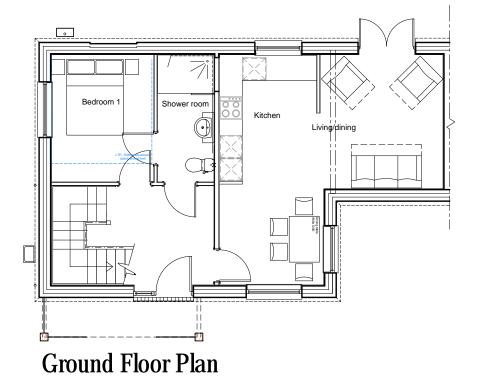RUIISEY Office
Building 300, The Grange, Romsey Roaw MitheinearchitsเปรียบAk
t: 01794 367703

Retirement Villages

Standard House Types

Reduced Area

Beaufort (Variation C)


Floor Plans


Ground and First

SCALE		DATE	AUTHOR	CHK'D
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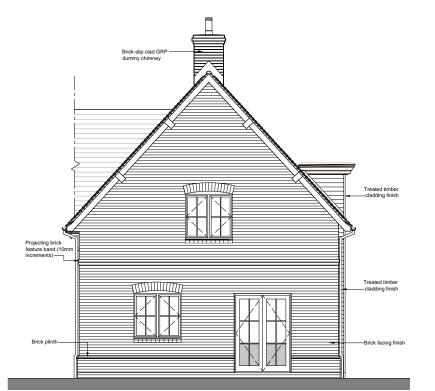
Housetype[]	BEAU	Variation[]	С	
Bedrooms[2	Persons[]	4	
Sq.ft[] finish[]	986	Sq.m[] finish[]	91.58	

PLOT No. As Drawn - 01, 11 Handed -



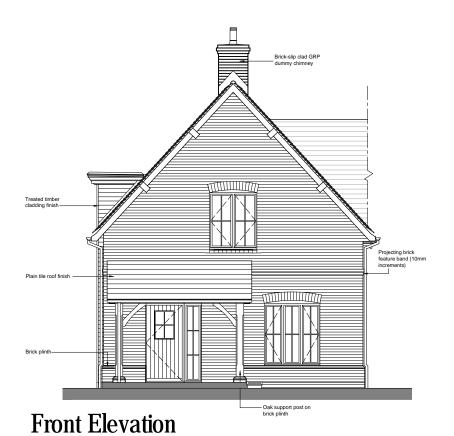

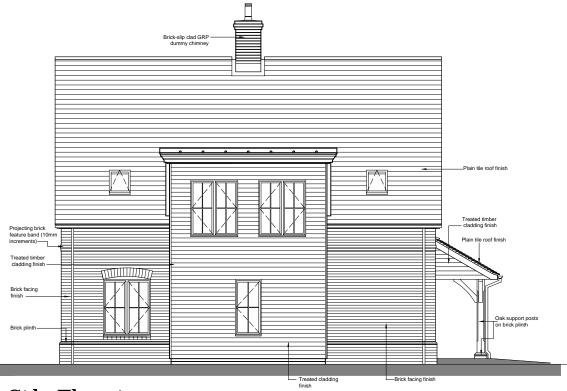Side Elevation



Example of Extra Care Cottages

Rear Elevation

Housetype[]	GUAR	Variation	Α	
Bedrooms[3	Persons	6	
Sq.ft[] finish[]	114.78	Sq.m[] finish	1236	

PLOT No. As Drawn -15,19,23 Handed - 22

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Romsey Office

Building 300, The Grange, Romsey Road, Michelmersh, SO51 0AE t: 01794 367703 f: 01794 367276 www.thrivearchitects.co.ul

Retirement Villages

Standard House Types


Reduced Area

Gaurds (Variation A)


Elevations

Front, Side and Rear


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First Floor Plan

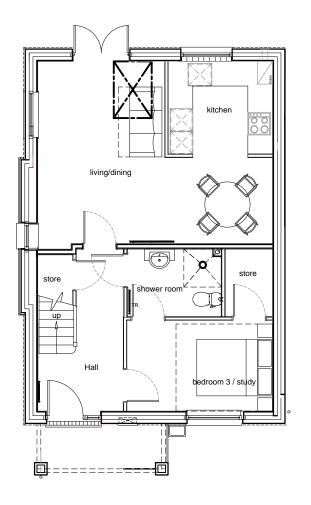


Roof Plan
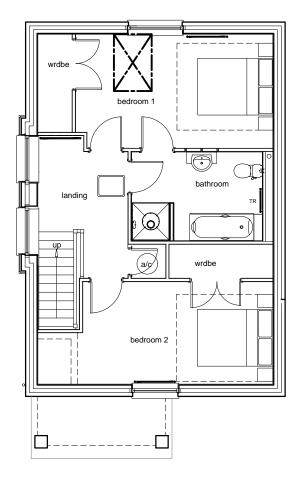
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PROJECT

Retirement Villages

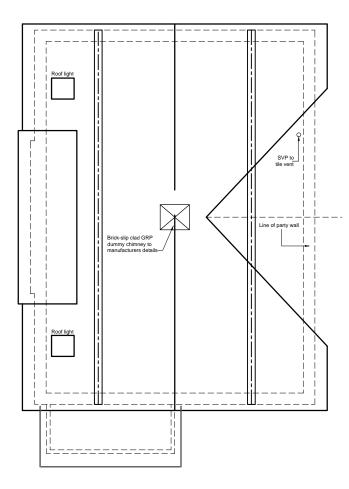Standard House Types

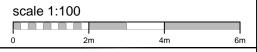Reduced Area

DRAWI

Gaurds (Variation A)

Ground, and First floor plans


and Roof scape

SCALE 1:100	@ A3	DATE 03/06/16	AUTHOR AM	CHK'D VJ
JOB NO.		DRAWING NO.		REV
-		HT.GAUR_A.p		
CLIENT REF				
-				


Housetype[]	GUAR	Variation	Α
Bedrooms[3	Persons	6
Sq.ft[] finish[]	114.78	Sq.m[] finish	1236

PLOT No. As Drawn -15,19,23 Handed - 22



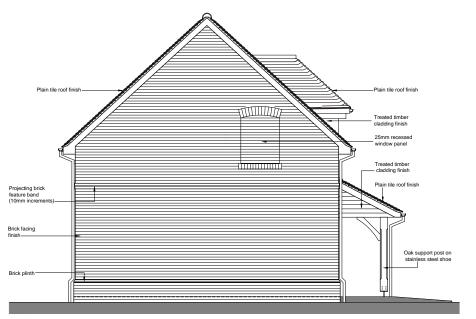


Front Elevation

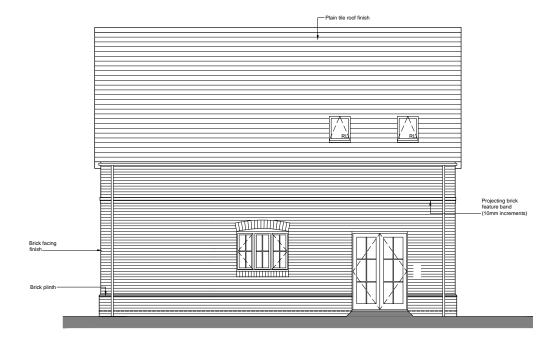

Rear Elevation

Side Elevation

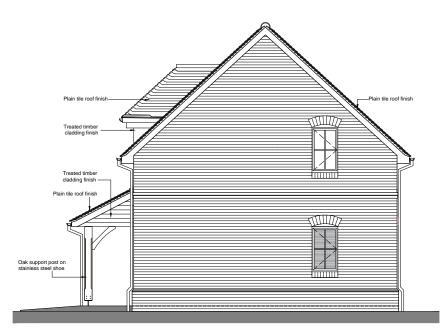

Side Elevation

Example of Extra Care Cottages

Housetype[]	HURL	Variation	А	PLO
Bedrooms[3	Persons	6	As
Sq.ft[] finish[]	110.02	Sq.m[] finish	1184	Har

PLOT No. As Drawn -03,10,12 Handed - 20,24,18

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REV DESCRIPTION DATE AUTH CHK'E



PLANNING



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DD O1FCT

Retirement Villages

Standard House Types

Reduced Area


DRAWI

Hurlston (Variation A)


Elevations

Front, Side and Rear

SCALE		DATE	AUTHOR	CHK'D
1:100	@ A3	03/06/16	AM	VJ
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JOB NO.		DRAWING NO.		REV
-		HT.HURL_A.e		
CLIENT REF	•			
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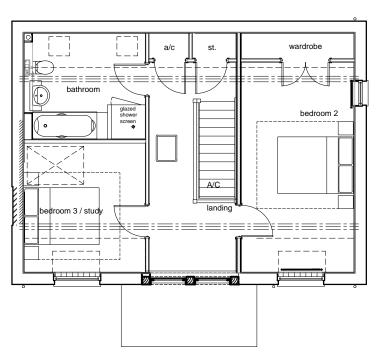


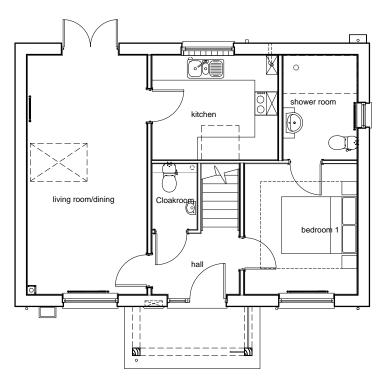Ground Floor Plan

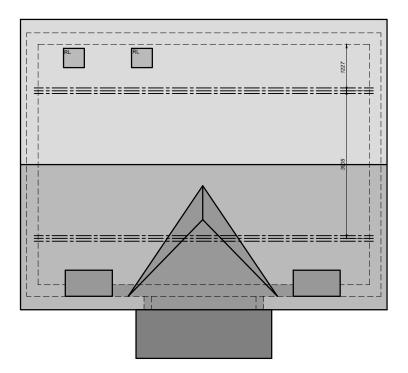

Roof Plan

Housetype[]	HURL	Variation	Α	PLOT No.
Bedrooms[3	Persons	6	As Drawn -03,10,12
Sq.ft[] finish[]	110.02	Sq.m[] finish	1184	Handed - 20,24,18



First Floor Plan

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PLANNING



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ROJECT

Retirement Villages

Standard House Types

Reduced Area


DRAWING

Hurlston (Variation A)

Ground, and First floor plans

and Roof scape

SCALE		DATE	AUTHOR	CHK'D
1:100	@ A3	03/06/16	AM	VJ
JOB NO.		DRAWING NO.		REV
-		HT.HURL_A.p		
CLIENT REF				
-				

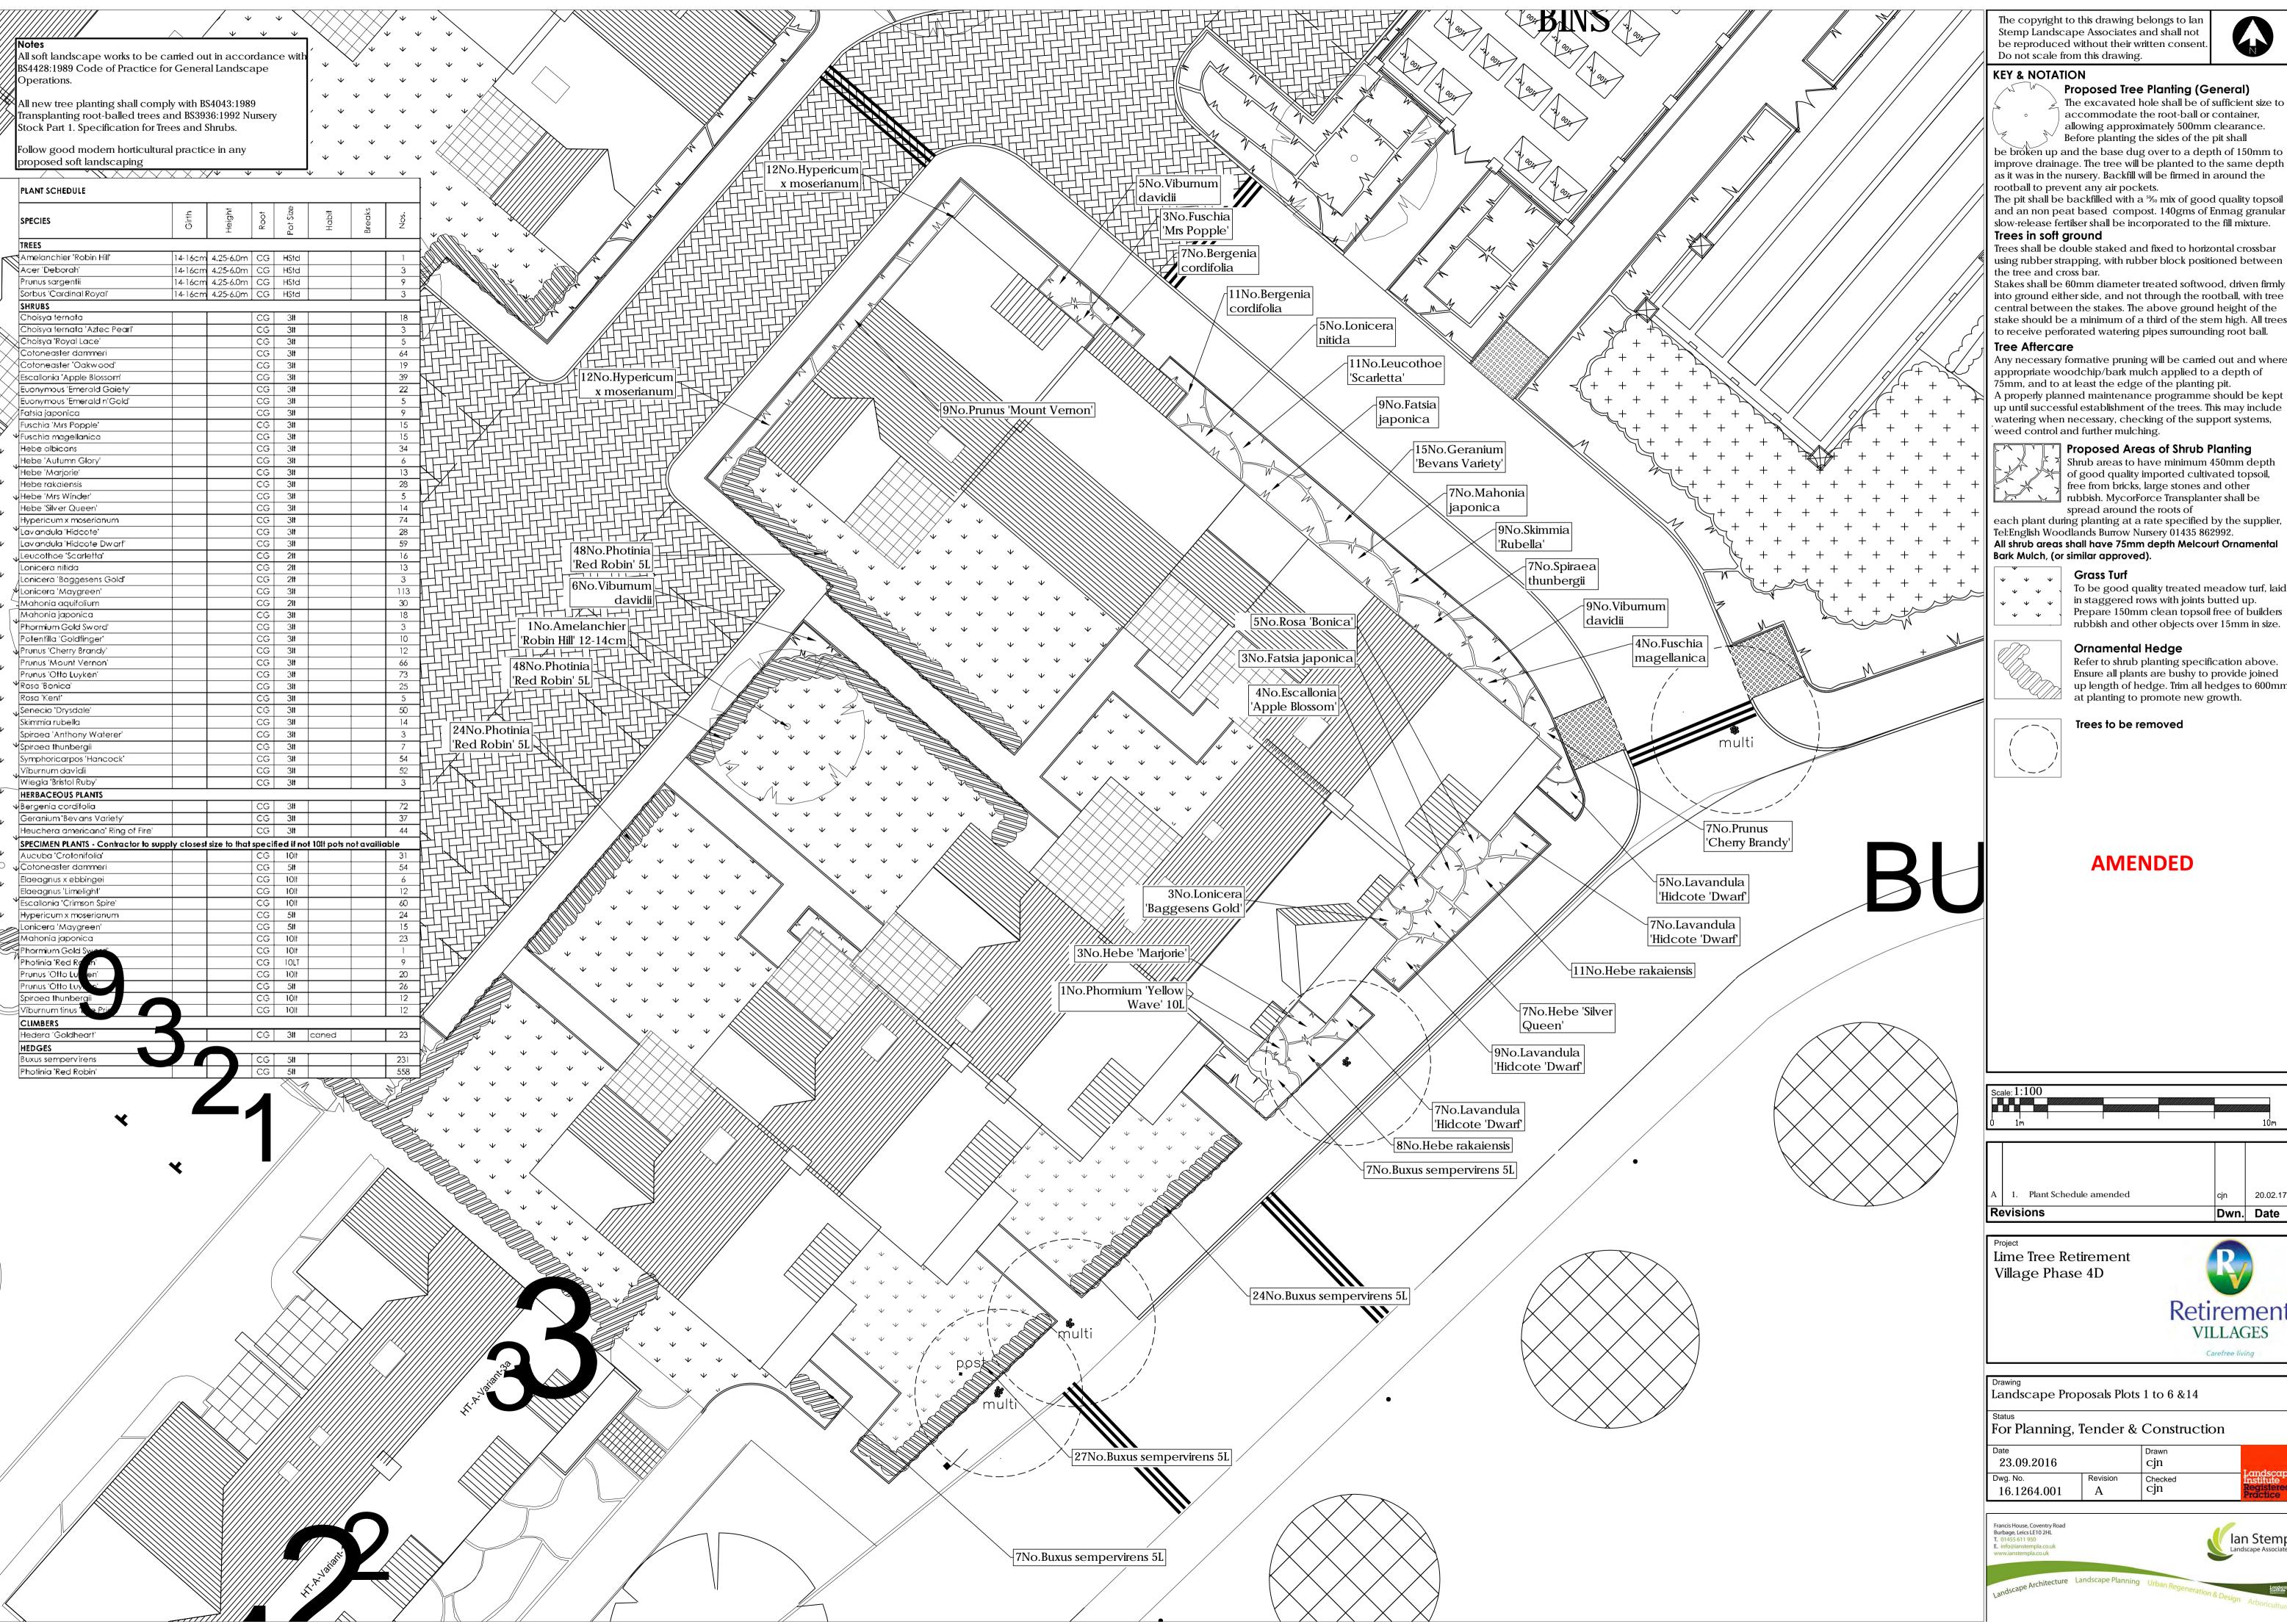

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Proposed Tree Planting (General)

The excavated hole shall be of sufficient size to accommodate the root-ball or container, allowing approximately 500mm clearance. Before planting the sides of the pit shall

be broken up and the base dug over to a depth of 150mm to improve drainage. The tree will be planted to the same depth as it was in the nursery. Backfill will be firmed in around the rootball to prevent any air pockets.

The pit shall be backfilled with a 5 mix of good quality topsoil and an non peat based compost. 140gms of Enmag granular

Trees shall be double staked and fixed to horizontal crossbar using rubber strapping, with rubber block positioned between

into ground either side, and not through the rootball, with tree central between the stakes. The above ground height of the stake should be a minimum of a third of the stem high. All trees to receive perforated watering pipes surrounding root ball.

Any necessary formative pruning will be carried out and where appropriate woodchip/bark mulch applied to a depth of 75mm, and to at least the edge of the planting pit. A properly planned maintenance programme should be kept up until successful establishment of the trees. This may include watering when necessary, checking of the support systems,

Proposed Areas of Shrub Planting

rubbish. MycorForce Transplanter shall be

Shrub areas to have minimum 450mm depth of good quality imported cultivated topsoil, free from bricks, large stones and other

each plant during planting at a rate specified by the supplier, Tel:English Woodlands Burrow Nursery 01435 862992. All shrub areas shall have 75mm depth Melcourt Ornamental

To be good quality treated meadow turf, laid in staggered rows with joints butted up. Prepare 150mm clean topsoil free of builders rubbish and other objects over 15mm in size.


Refer to shrub planting specification above. Ensure all plants are bushy to provide joined

up length of hedge. Trim all hedges to 600mm at planting to promote new growth.

Trees to be removed



AMENDED

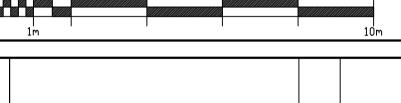

1. Plant Schedule amended 20.02.17 Dwn. Date

Lime Tree Retirement Village Phase 4D




Landscape Proposals Plots 1 to 6 &14


For Planning, Tender & Construction

cjn Checked Cjn A



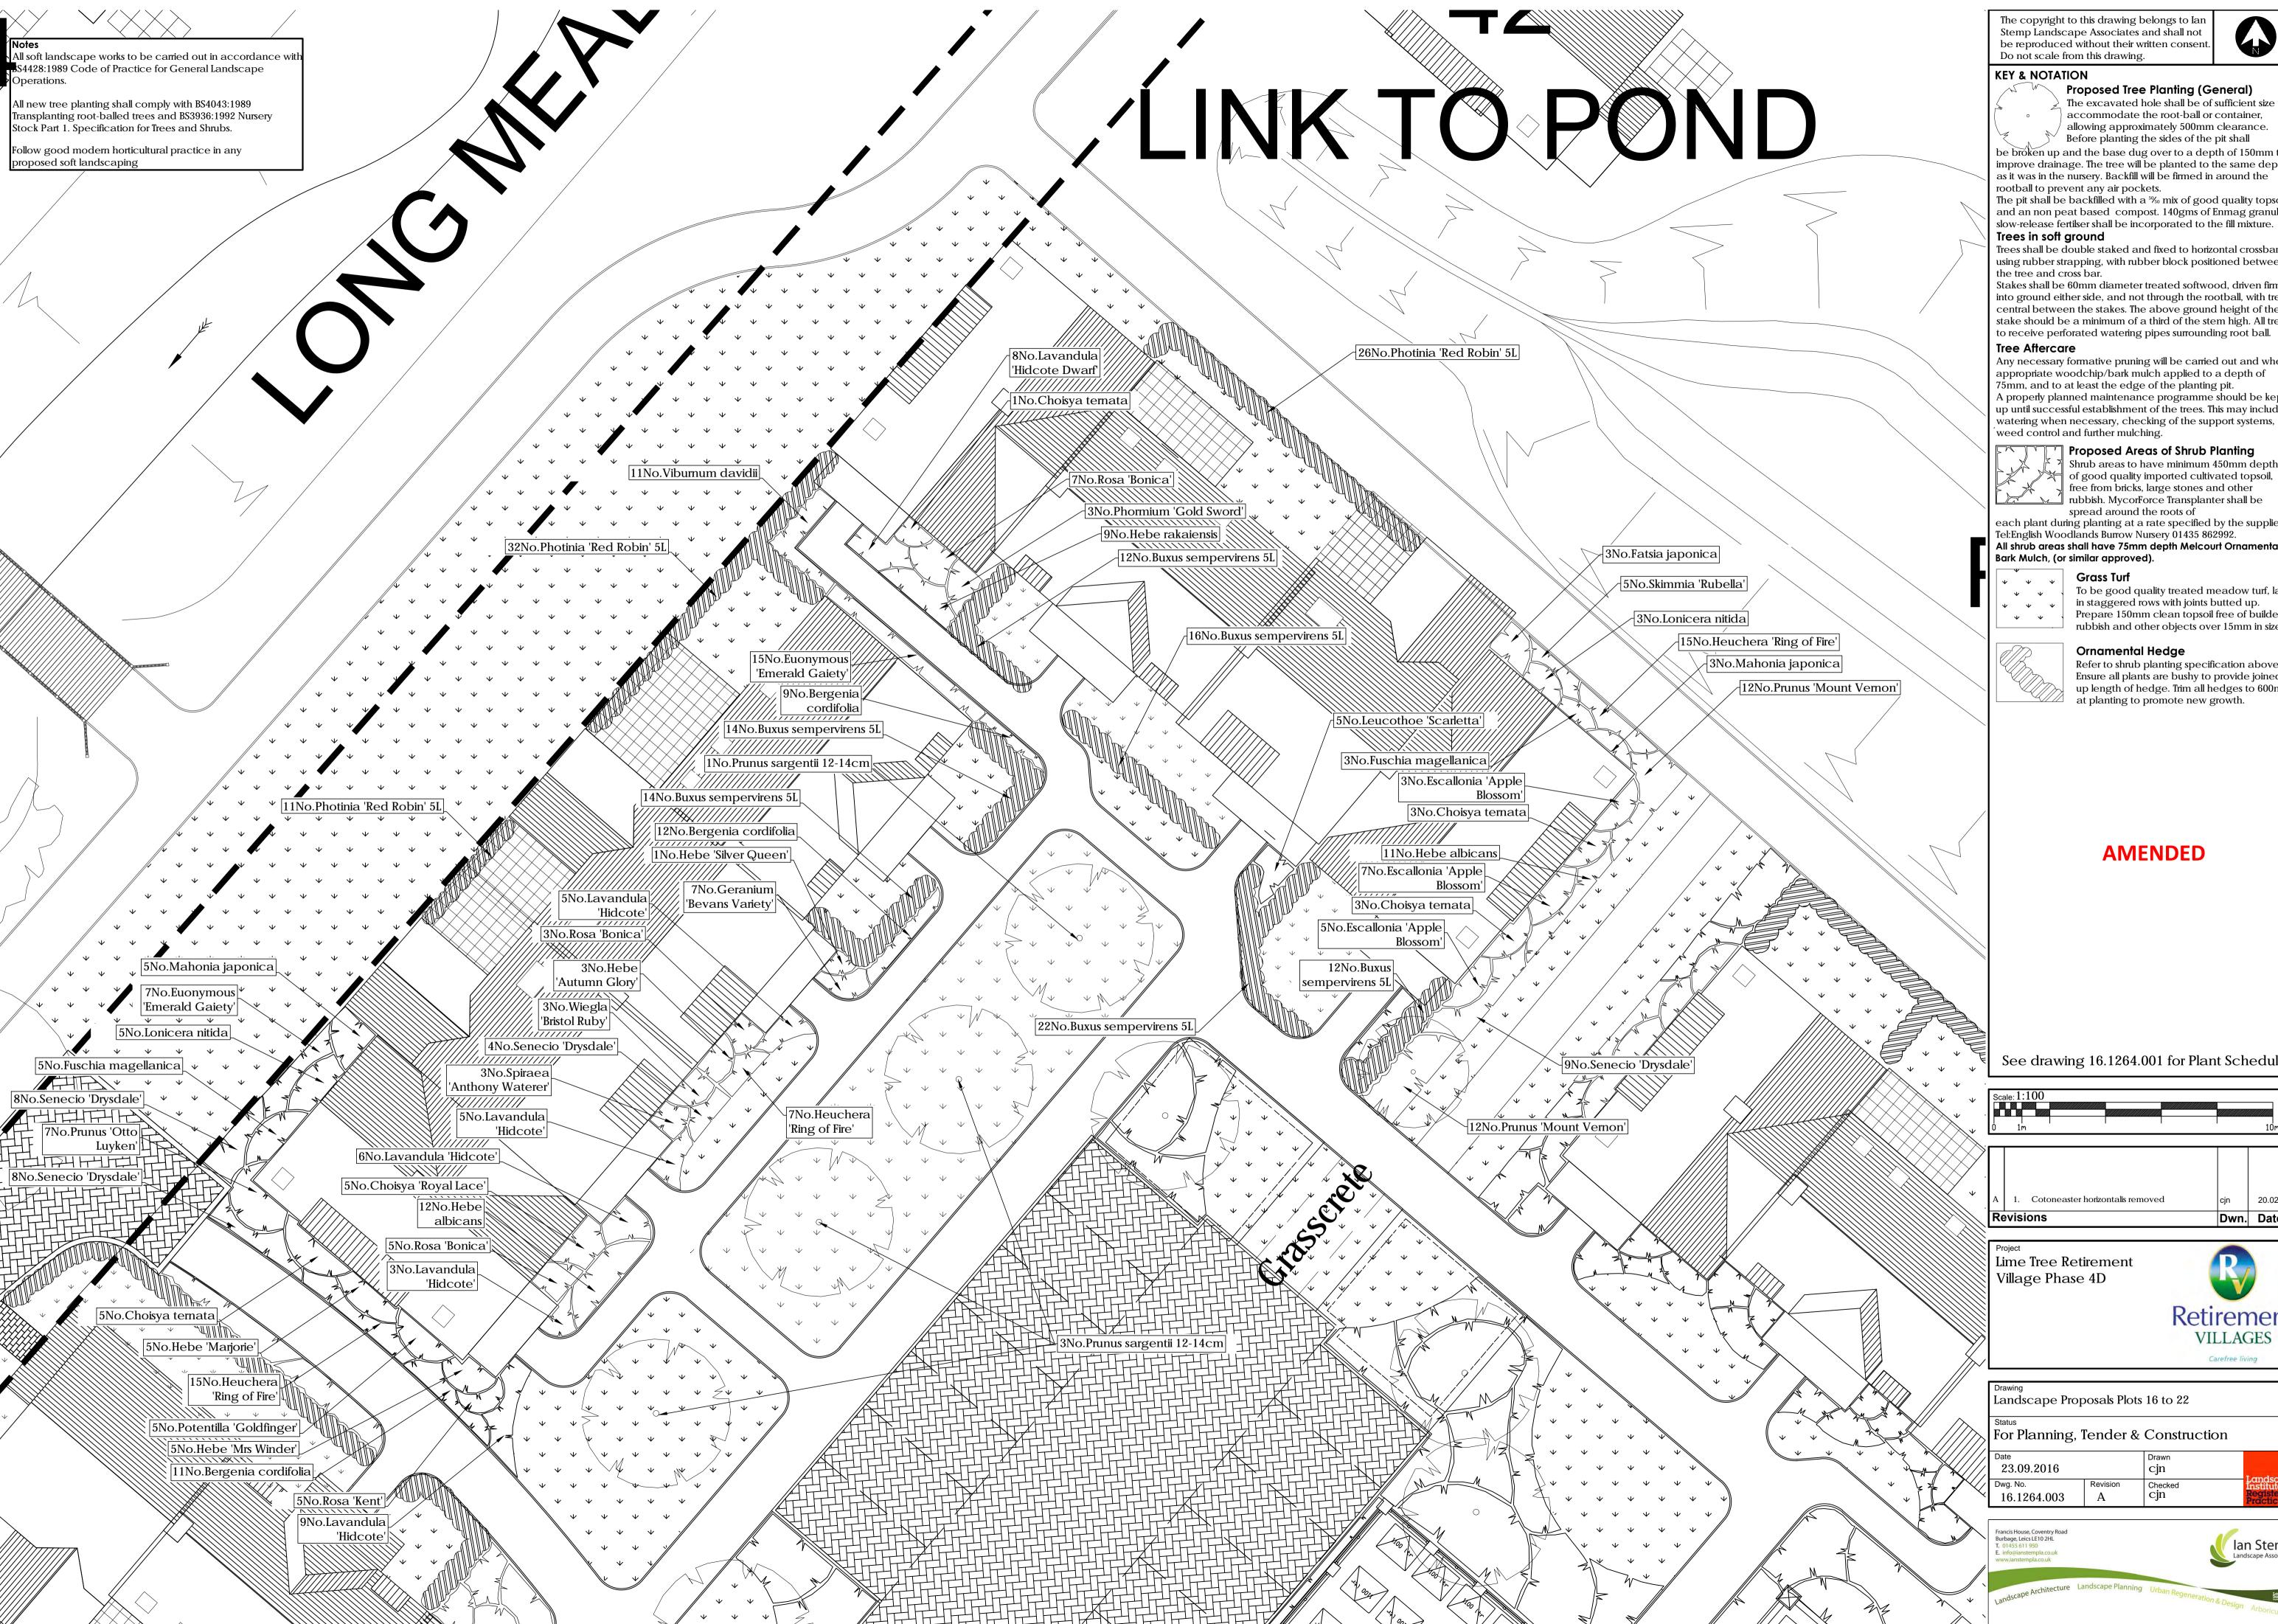

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Proposed Tree Planting (General)

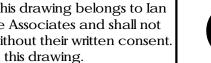The excavated hole shall be of sufficient size to accommodate the root-ball or container, allowing approximately 500mm clearance.

Before planting the sides of the pit shall be broken up and the base dug over to a depth of 150mm to improve drainage. The tree will be planted to the same depth as it was in the nursery. Backfill will be firmed in around the

The pit shall be backfilled with a 5% mix of good quality topsoil and an non peat based compost. 140gms of Enmag granular slow-release fertilser shall be incorporated to the fill mixture.

Trees shall be double staked and fixed to horizontal crossbar using rubber strapping, with rubber block positioned between

Stakes shall be 60mm diameter treated softwood, driven firmly into ground either side, and not through the rootball, with tree central between the stakes. The above ground height of the stake should be a minimum of a third of the stem high. All trees

Any necessary formative pruning will be carried out and where appropriate woodchip/bark mulch applied to a depth of 75mm, and to at least the edge of the planting pit. A properly planned maintenance programme should be kept up until successful establishment of the trees. This may include watering when necessary, checking of the support systems,

> Proposed Areas of Shrub Planting Shrub areas to have minimum 450mm depth

of good quality imported cultivated topsoil, free from bricks, large stones and other rubbish. MycorForce Transplanter shall be spread around the roots of

each plant during planting at a rate specified by the supplier, Tel:English Woodlands Burrow Nursery 01435 862992. All shrub areas shall have 75mm depth Melcourt Ornamental


To be good quality treated meadow turf, laid in staggered rows with joints butted up. Prepare 150mm clean topsoil free of builders rubbish and other objects over 15mm in size.

Ornamental Hedge

Refer to shrub planting specification above. Ensure all plants are bushy to provide joined up length of hedge. Trim all hedges to 600mm at planting to promote new growth.

AMENDED

See drawing 16.1264.001 for Plant Schedule

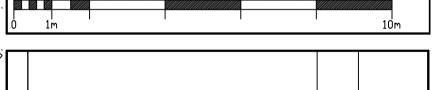


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Lime Tree Retirement



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23.09.2016		cjn	Landscape				
/g. No.	Revision	Checked	Institute *				
6.1264.003	A	cjn	Registered Practice				



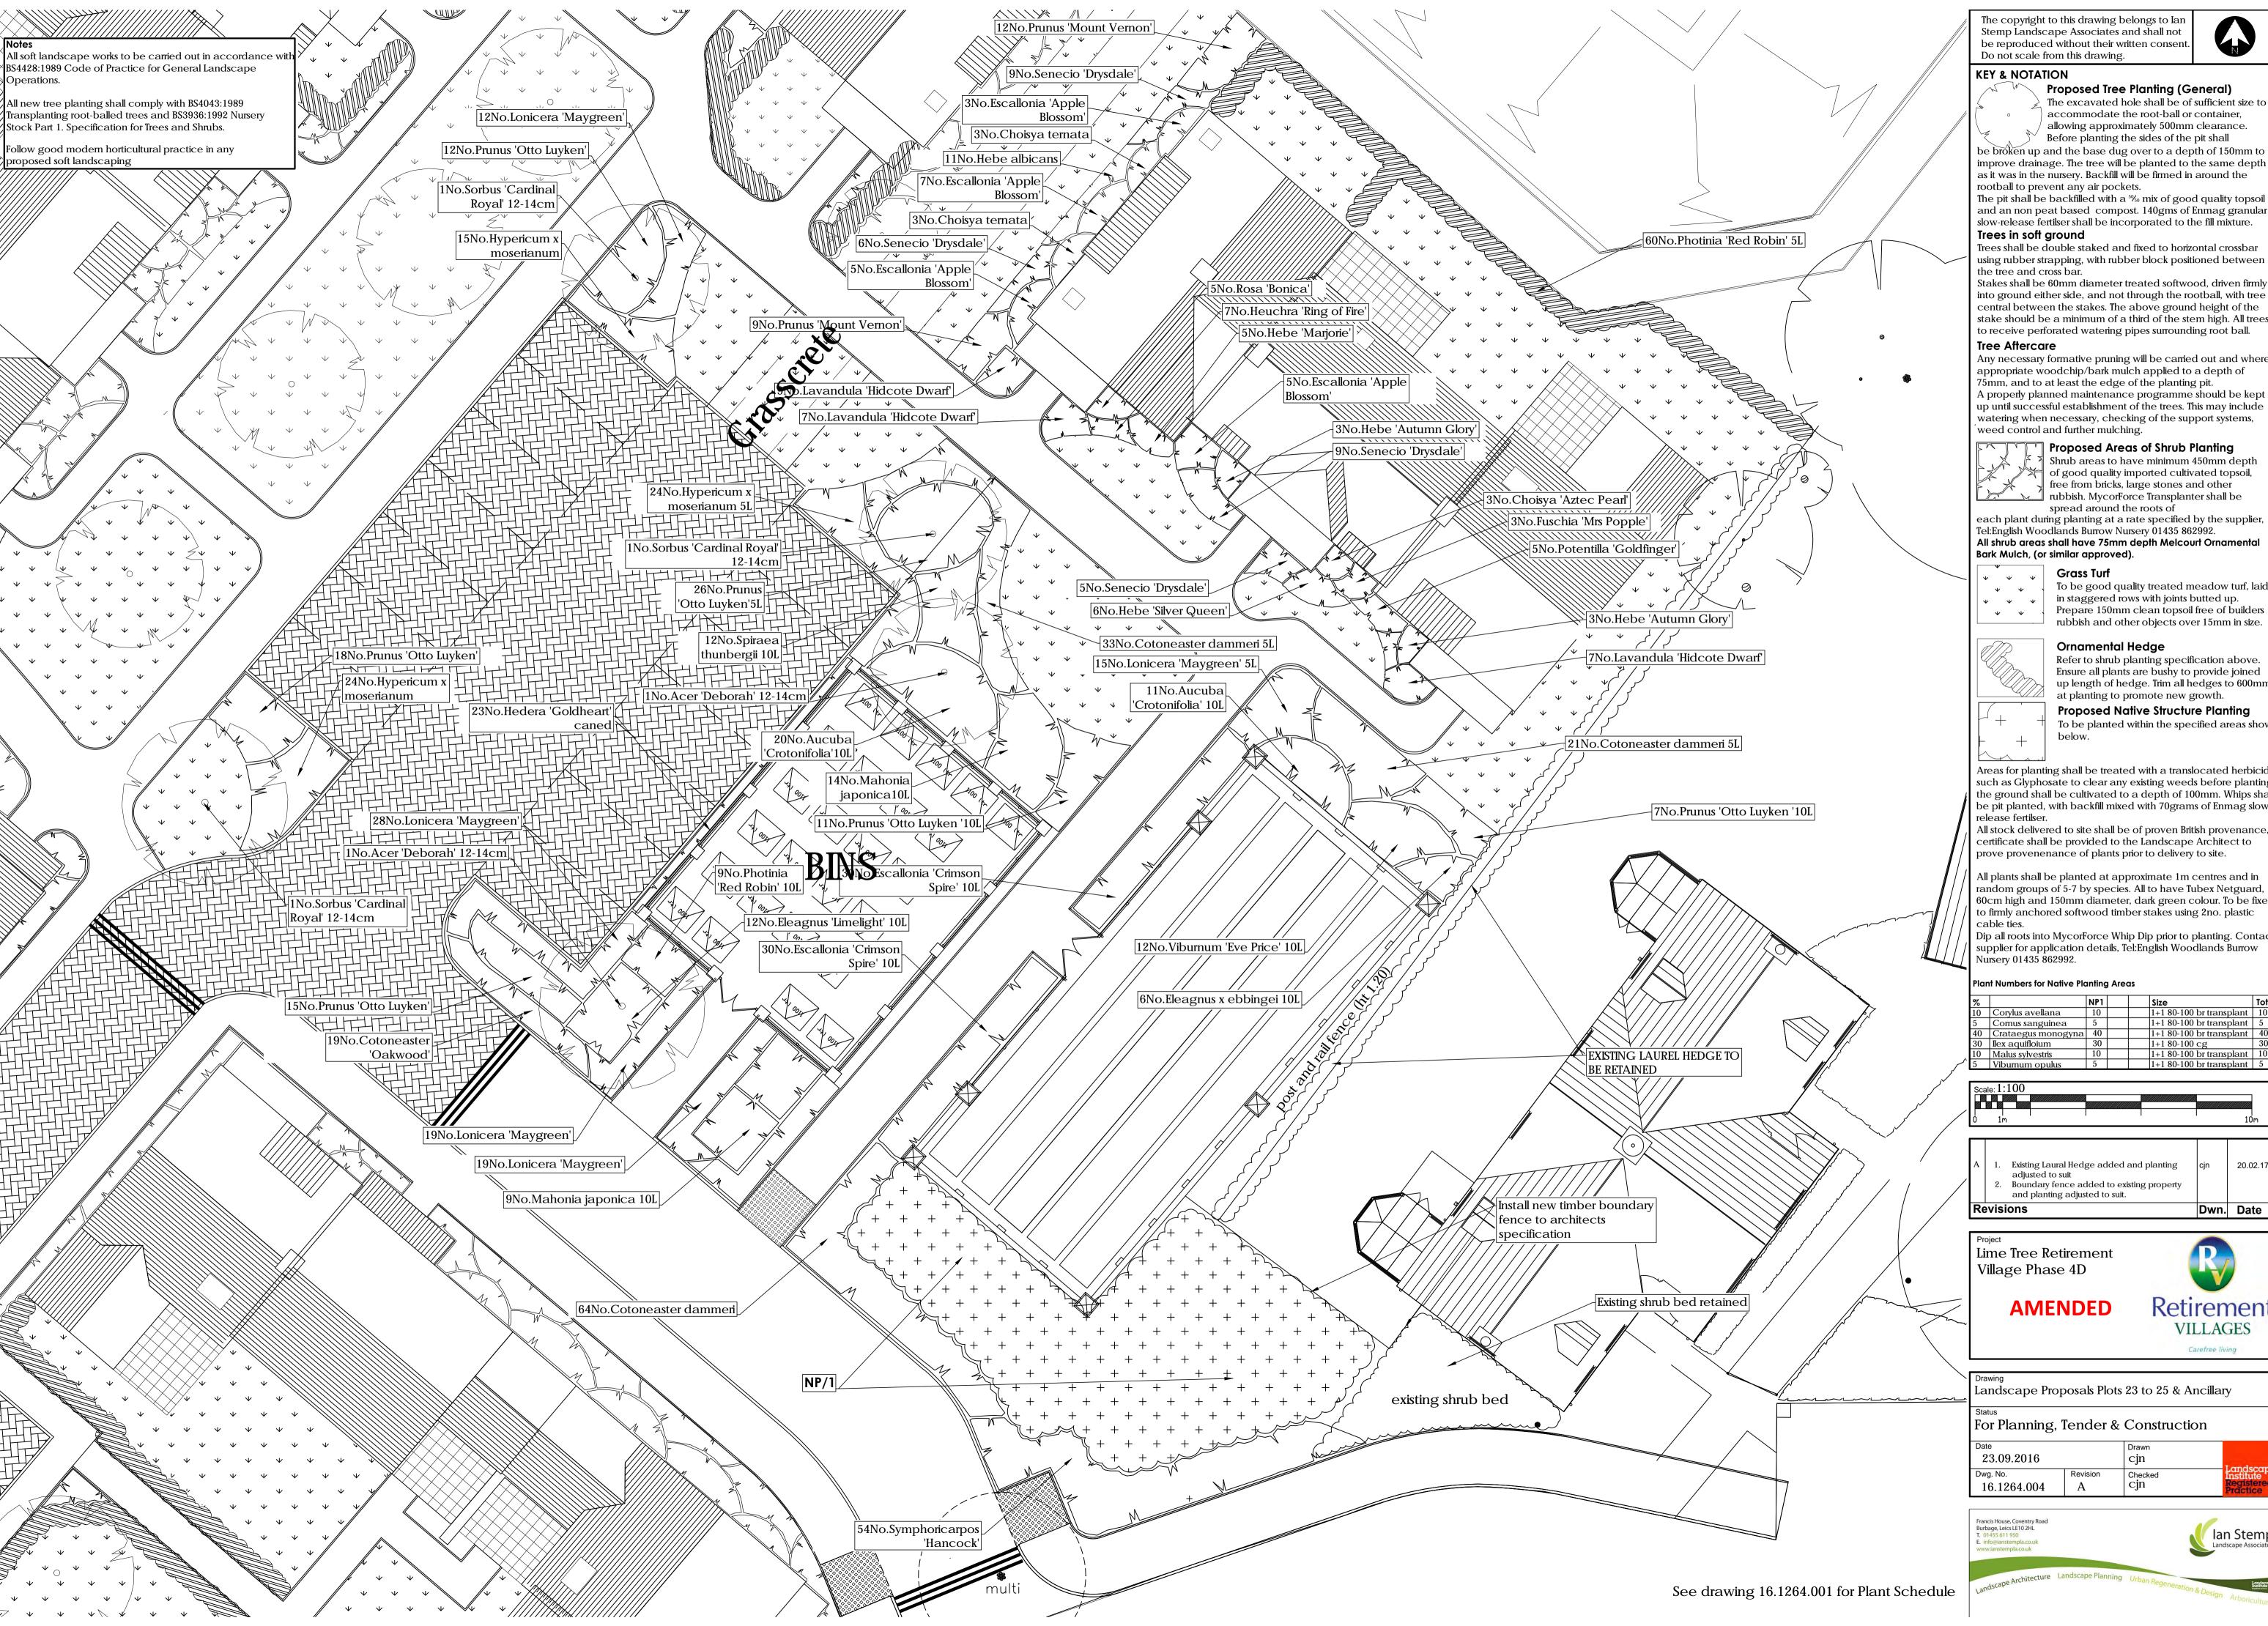

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Proposed Tree Planting (General) The excavated hole shall be of sufficient size to accommodate the root-ball or container, allowing approximately 500mm clearance.

Before planting the sides of the pit shall be broken up and the base dug over to a depth of 150mm to improve drainage. The tree will be planted to the same depth as it was in the nursery. Backfill will be firmed in around the


The pit shall be backfilled with a 5% mix of good quality topsoil and an non peat based compost. 140gms of Enmag granular slow-release fertilser shall be incorporated to the fill mixture.

Trees in soft ground Trees shall be double staked and fixed to horizontal crossbar

using rubber strapping, with rubber block positioned between the tree and cross bar. Stakes shall be 60mm diameter treated softwood, driven firmly

into ground either side, and not through the rootball, with tree

Any necessary formative pruning will be carried out and where appropriate woodchip/bark mulch applied to a depth of 75mm, and to at least the edge of the planting pit. A properly planned maintenance programme should be kept up until successful establishment of the trees. This may include watering when necessary, checking of the support systems,

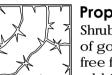

Proposed Areas of Shrub Planting

Shrub areas to have minimum 450mm depth of good quality imported cultivated topsoil, free from bricks, large stones and other rubbish. MycorForce Transplanter shall be

each plant during planting at a rate specified by the supplier, Tel:English Woodlands Burrow Nursery 01435 862992. All shrub areas shall have 75mm depth Melcourt Ornamental

To be good quality treated meadow turf, laid in staggered rows with joints butted up. Prepare 150mm clean topsoil free of builders rubbish and other objects over 15mm in size.

Ornamental Hedge

Refer to shrub planting specification above. Ensure all plants are bushy to provide joined up length of hedge. Trim all hedges to 600mm

Proposed Native Structure Planting To be planted within the specified areas shown below.

Areas for planting shall be treated with a translocated herbicide such as Glyphosate to clear any existing weeds before planting, the ground shall be cultivated to a depth of 100mm. Whips shall be pit planted, with backfill mixed with 70 grams of Enmag slow

All stock delivered to site shall be of proven British provenance, a certificate shall be provided to the Landscape Architect to

All plants shall be planted at approximate 1m centres and in random groups of 5-7 by species. All to have Tubex Netguard, 60cm high and 150mm diameter, dark green colour. To be fixed

to firmly anchored softwood timber stakes using 2no. plastic Dip all roots into MycorForce Whip Dip prior to planting. Contact

supplier for application details, Tel:English Woodlands Burrow

Plant Numbers for Native Planting Areas

6		NP1		Size	Totals	
0	Corylus avellana	10		1+1 80-100 br transplant	10	
	Cornus sanguinea	5		1+1 80-100 br transplant	5	
0	Crataegus monogyna	40		1+1 80-100 br transplant	40	
0	Ilex aquifloium	30		1+1 80-100 cg	30	
0	Malus sylvestris	10		1+1 80-100 br transplant	10	
	Viburnum opulus	5		1+1 80-100 br transplant	5	




Existing Laural Hedge added and planting 20.02.17 Boundary fence added to existing property and planting adjusted to suit. Dwn. Date


Lime Tree Retirement Village Phase 4D




Landscape Proposals Plots 23 to 25 & Ancillary For Planning, Tender & Construction Checked



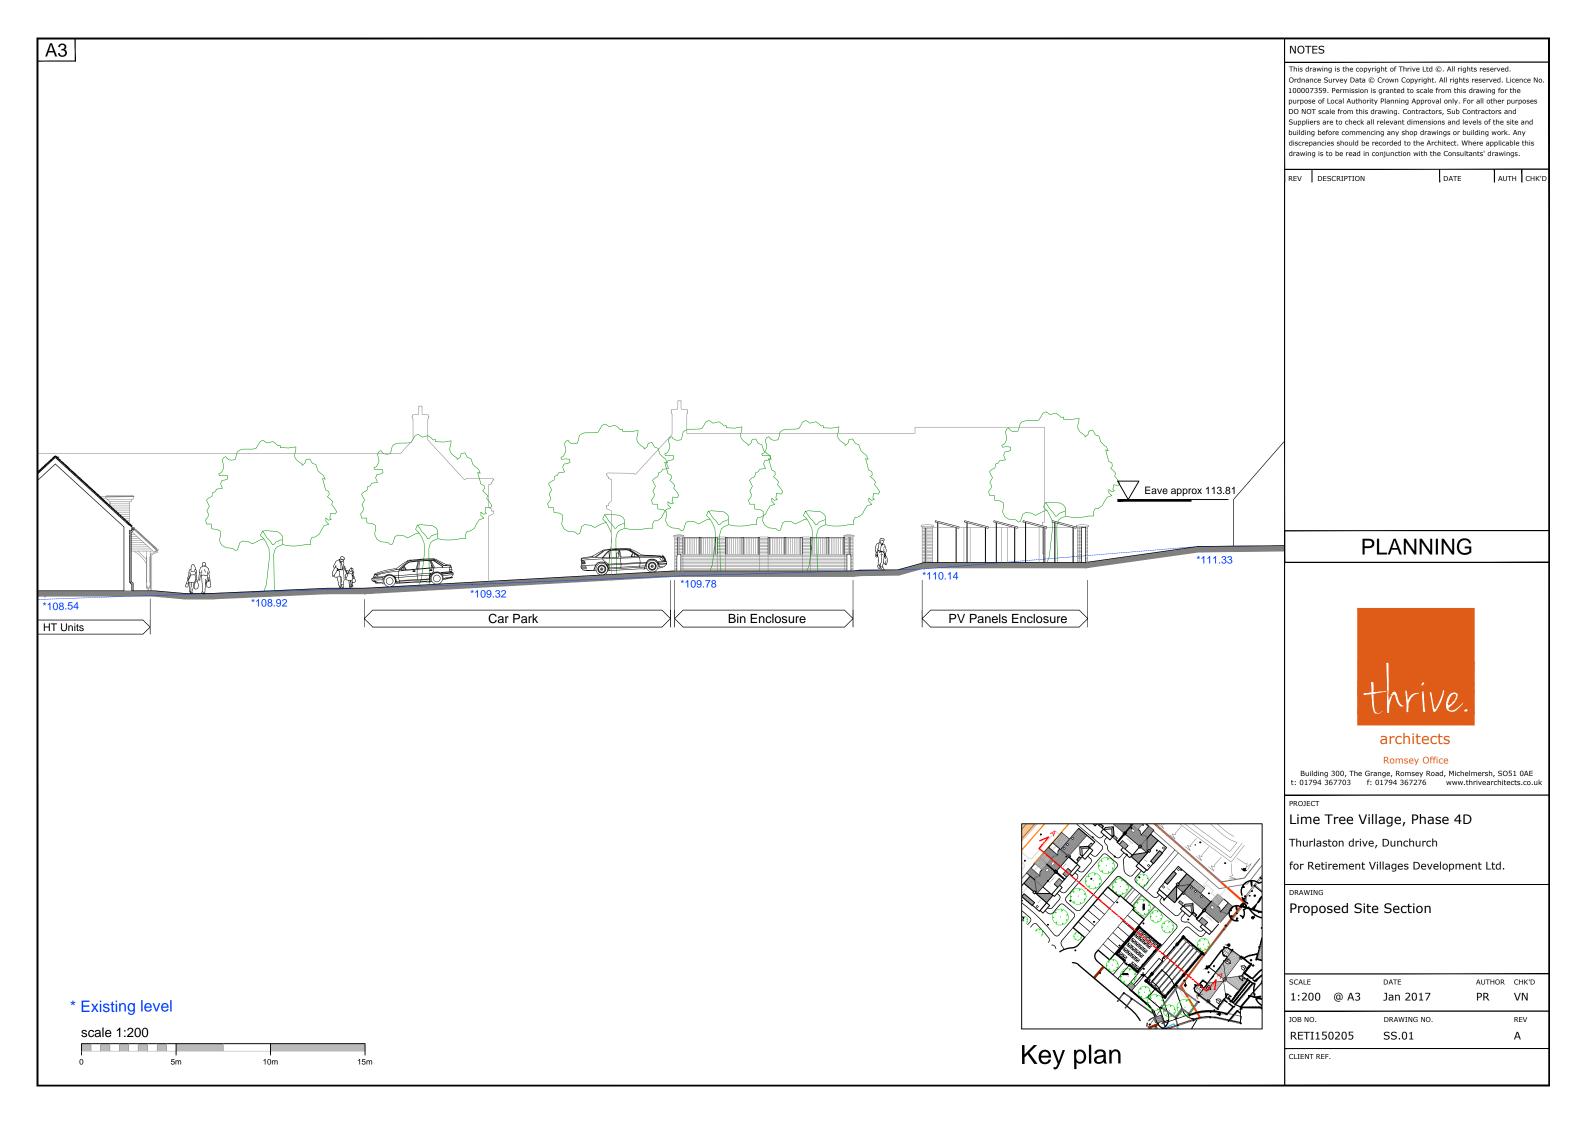

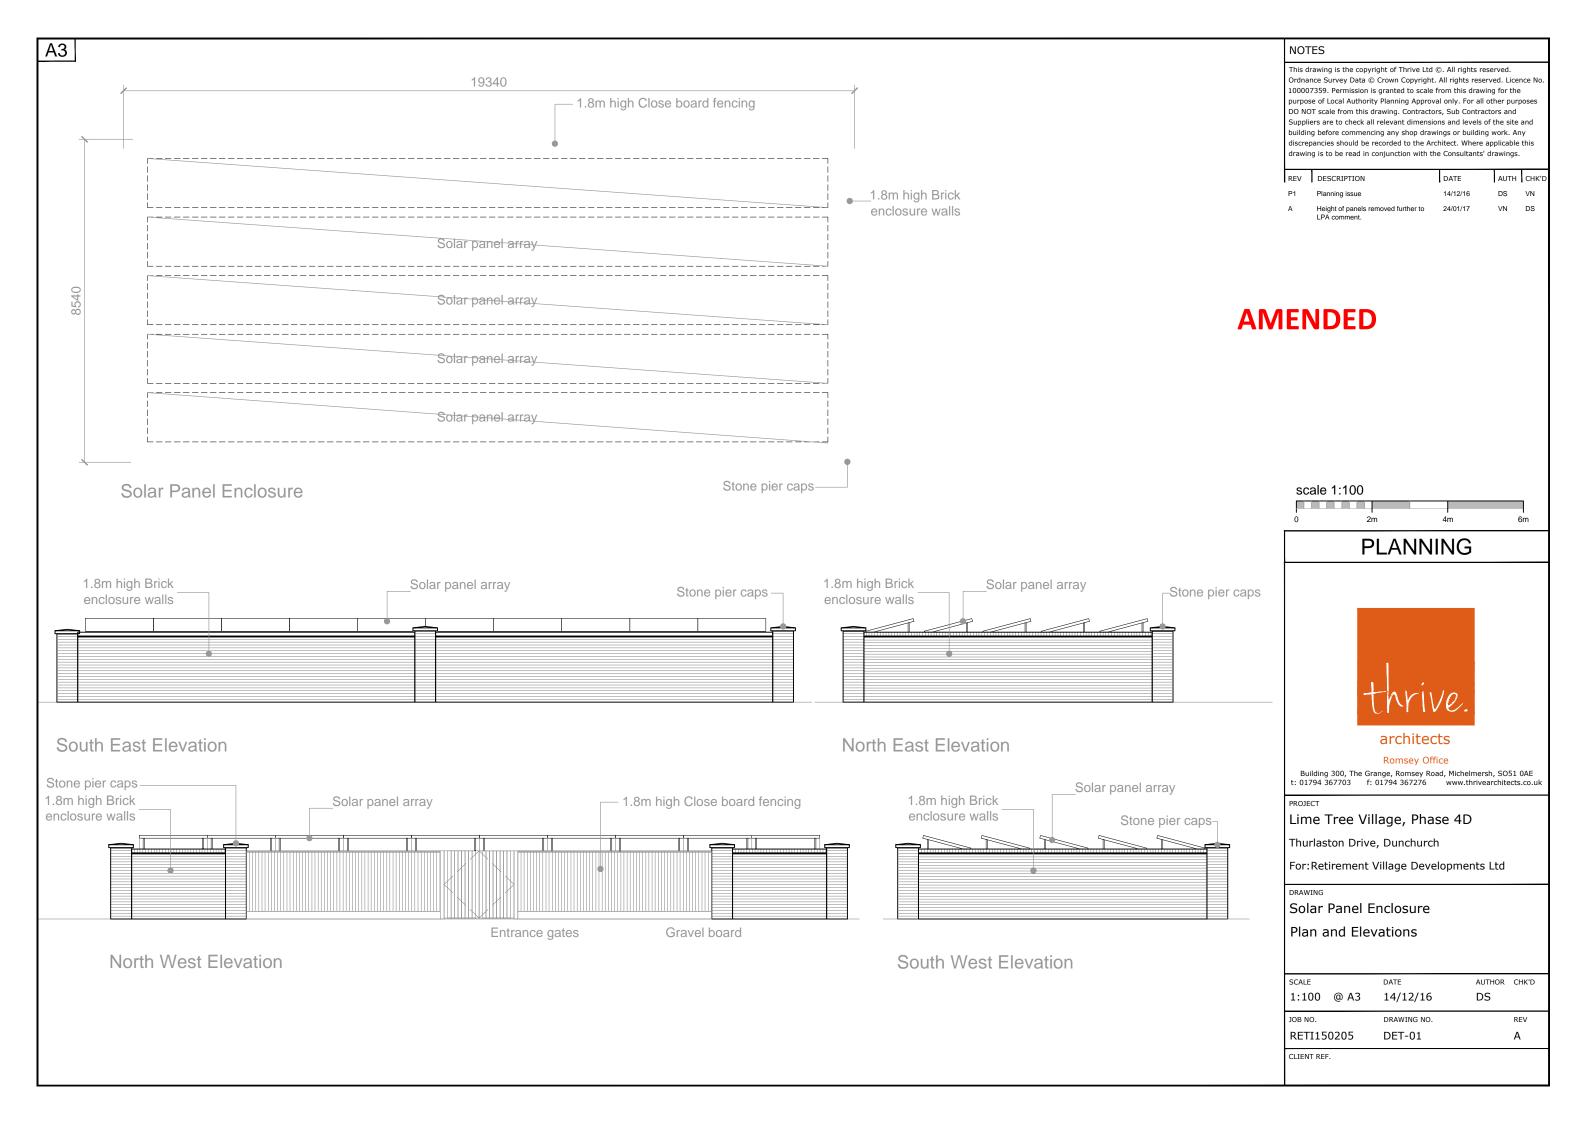

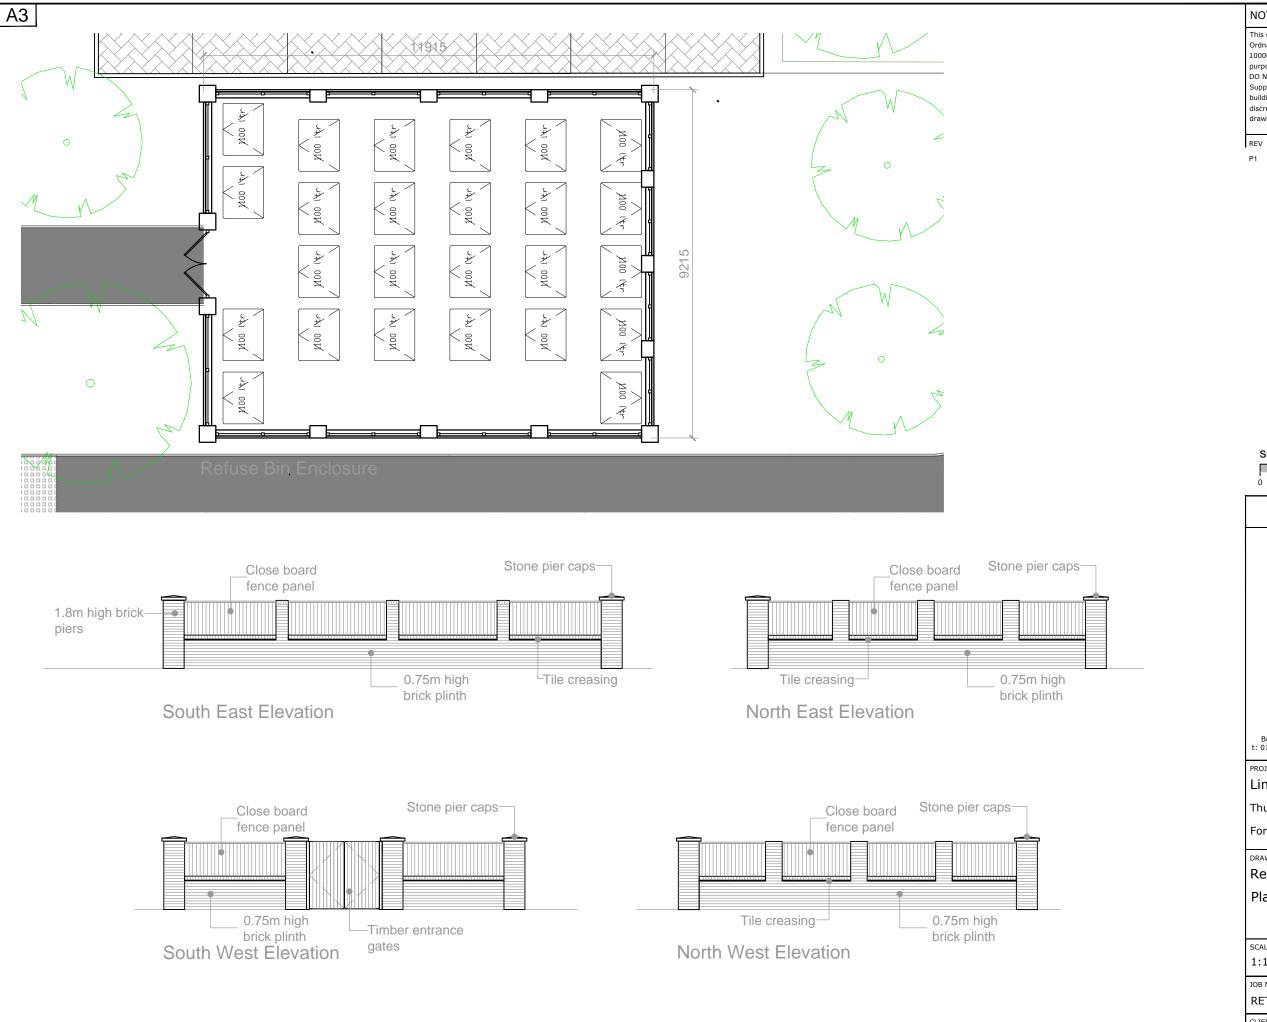

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REV	DESCRIPTION	DATE	AUTH	CHK'D
P1	Planning issue	14/12/16	DS	VN



PLANNING



Romsey Office

Building 300, The Grange, Romsey Road, Michelmersh, SO51 0AE t: 01794 367703 f: 01794 367276 www.thrivearchitects.co.ul

Lime Tree Village, Phase 4D

Thurlaston Drive, Dunchurch

For:Retirement Village Developments Ltd

Refuse Bin Enclosure Plan and Elevations

SCALE	DATE	AUTHOR CHK'D
1:100 @ A3	14/12/16	DS
JOB NO.	DRAWING NO.	REV
RETI150205	DET-02	P1
CLIENT REF.		
















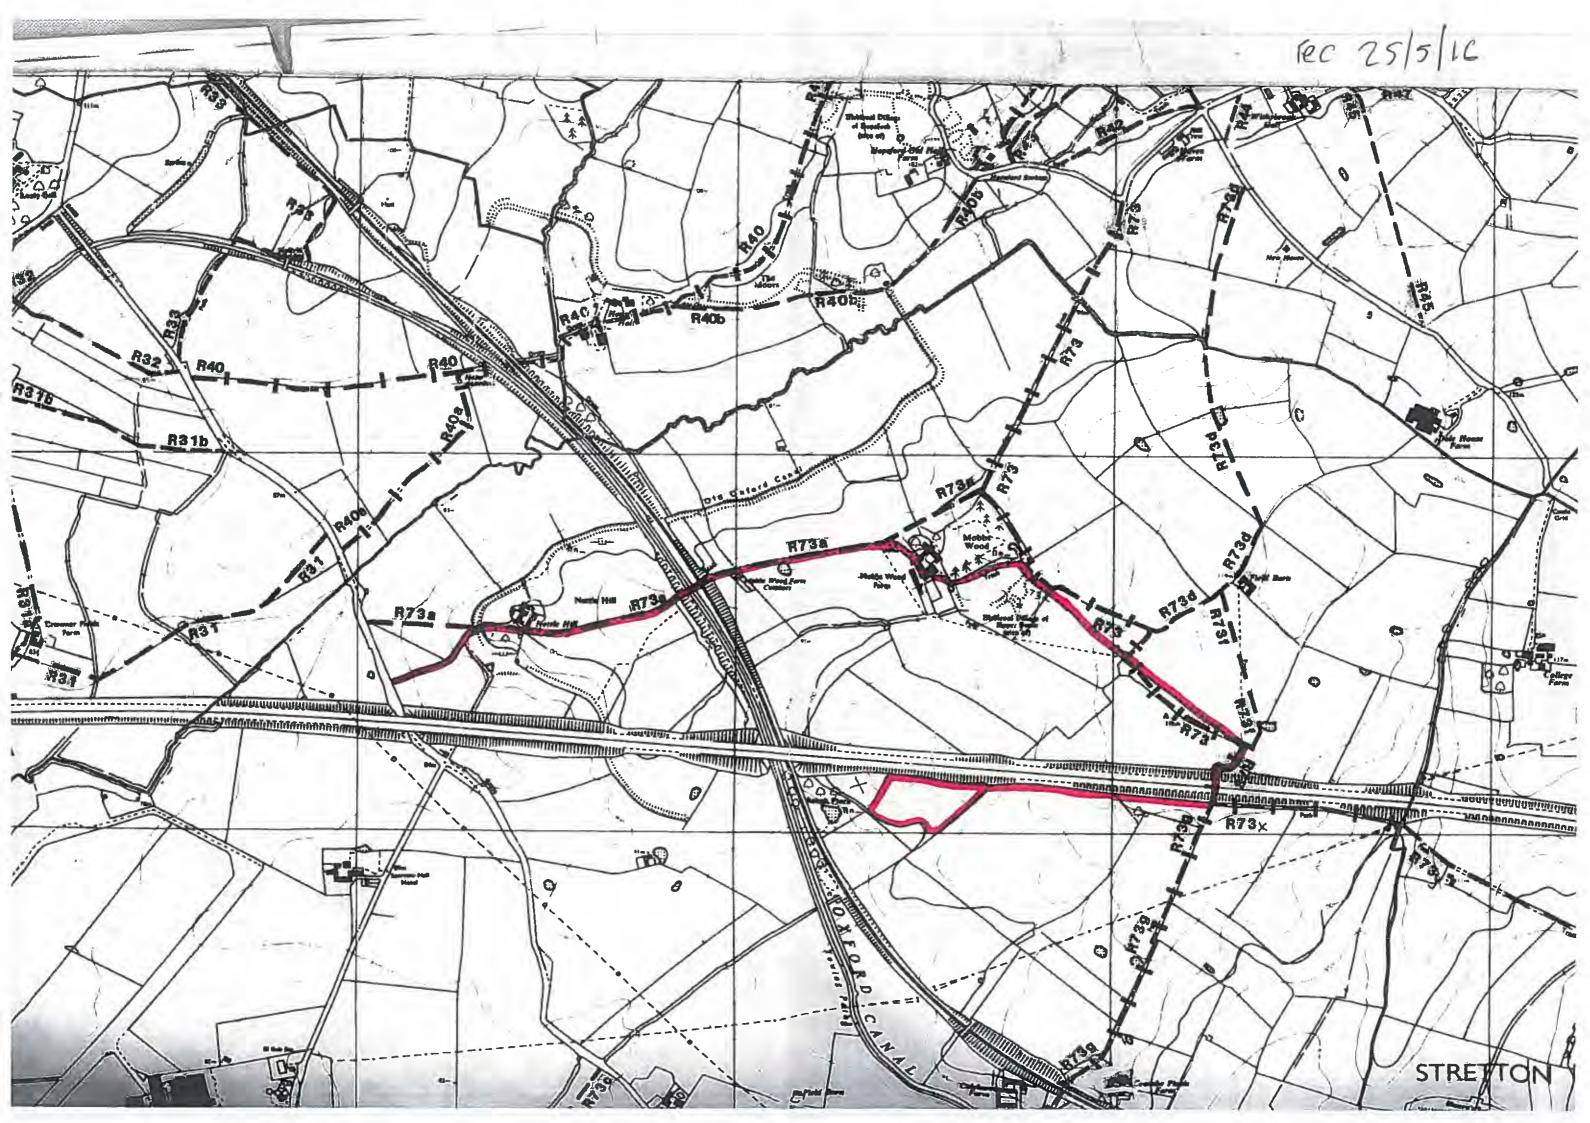


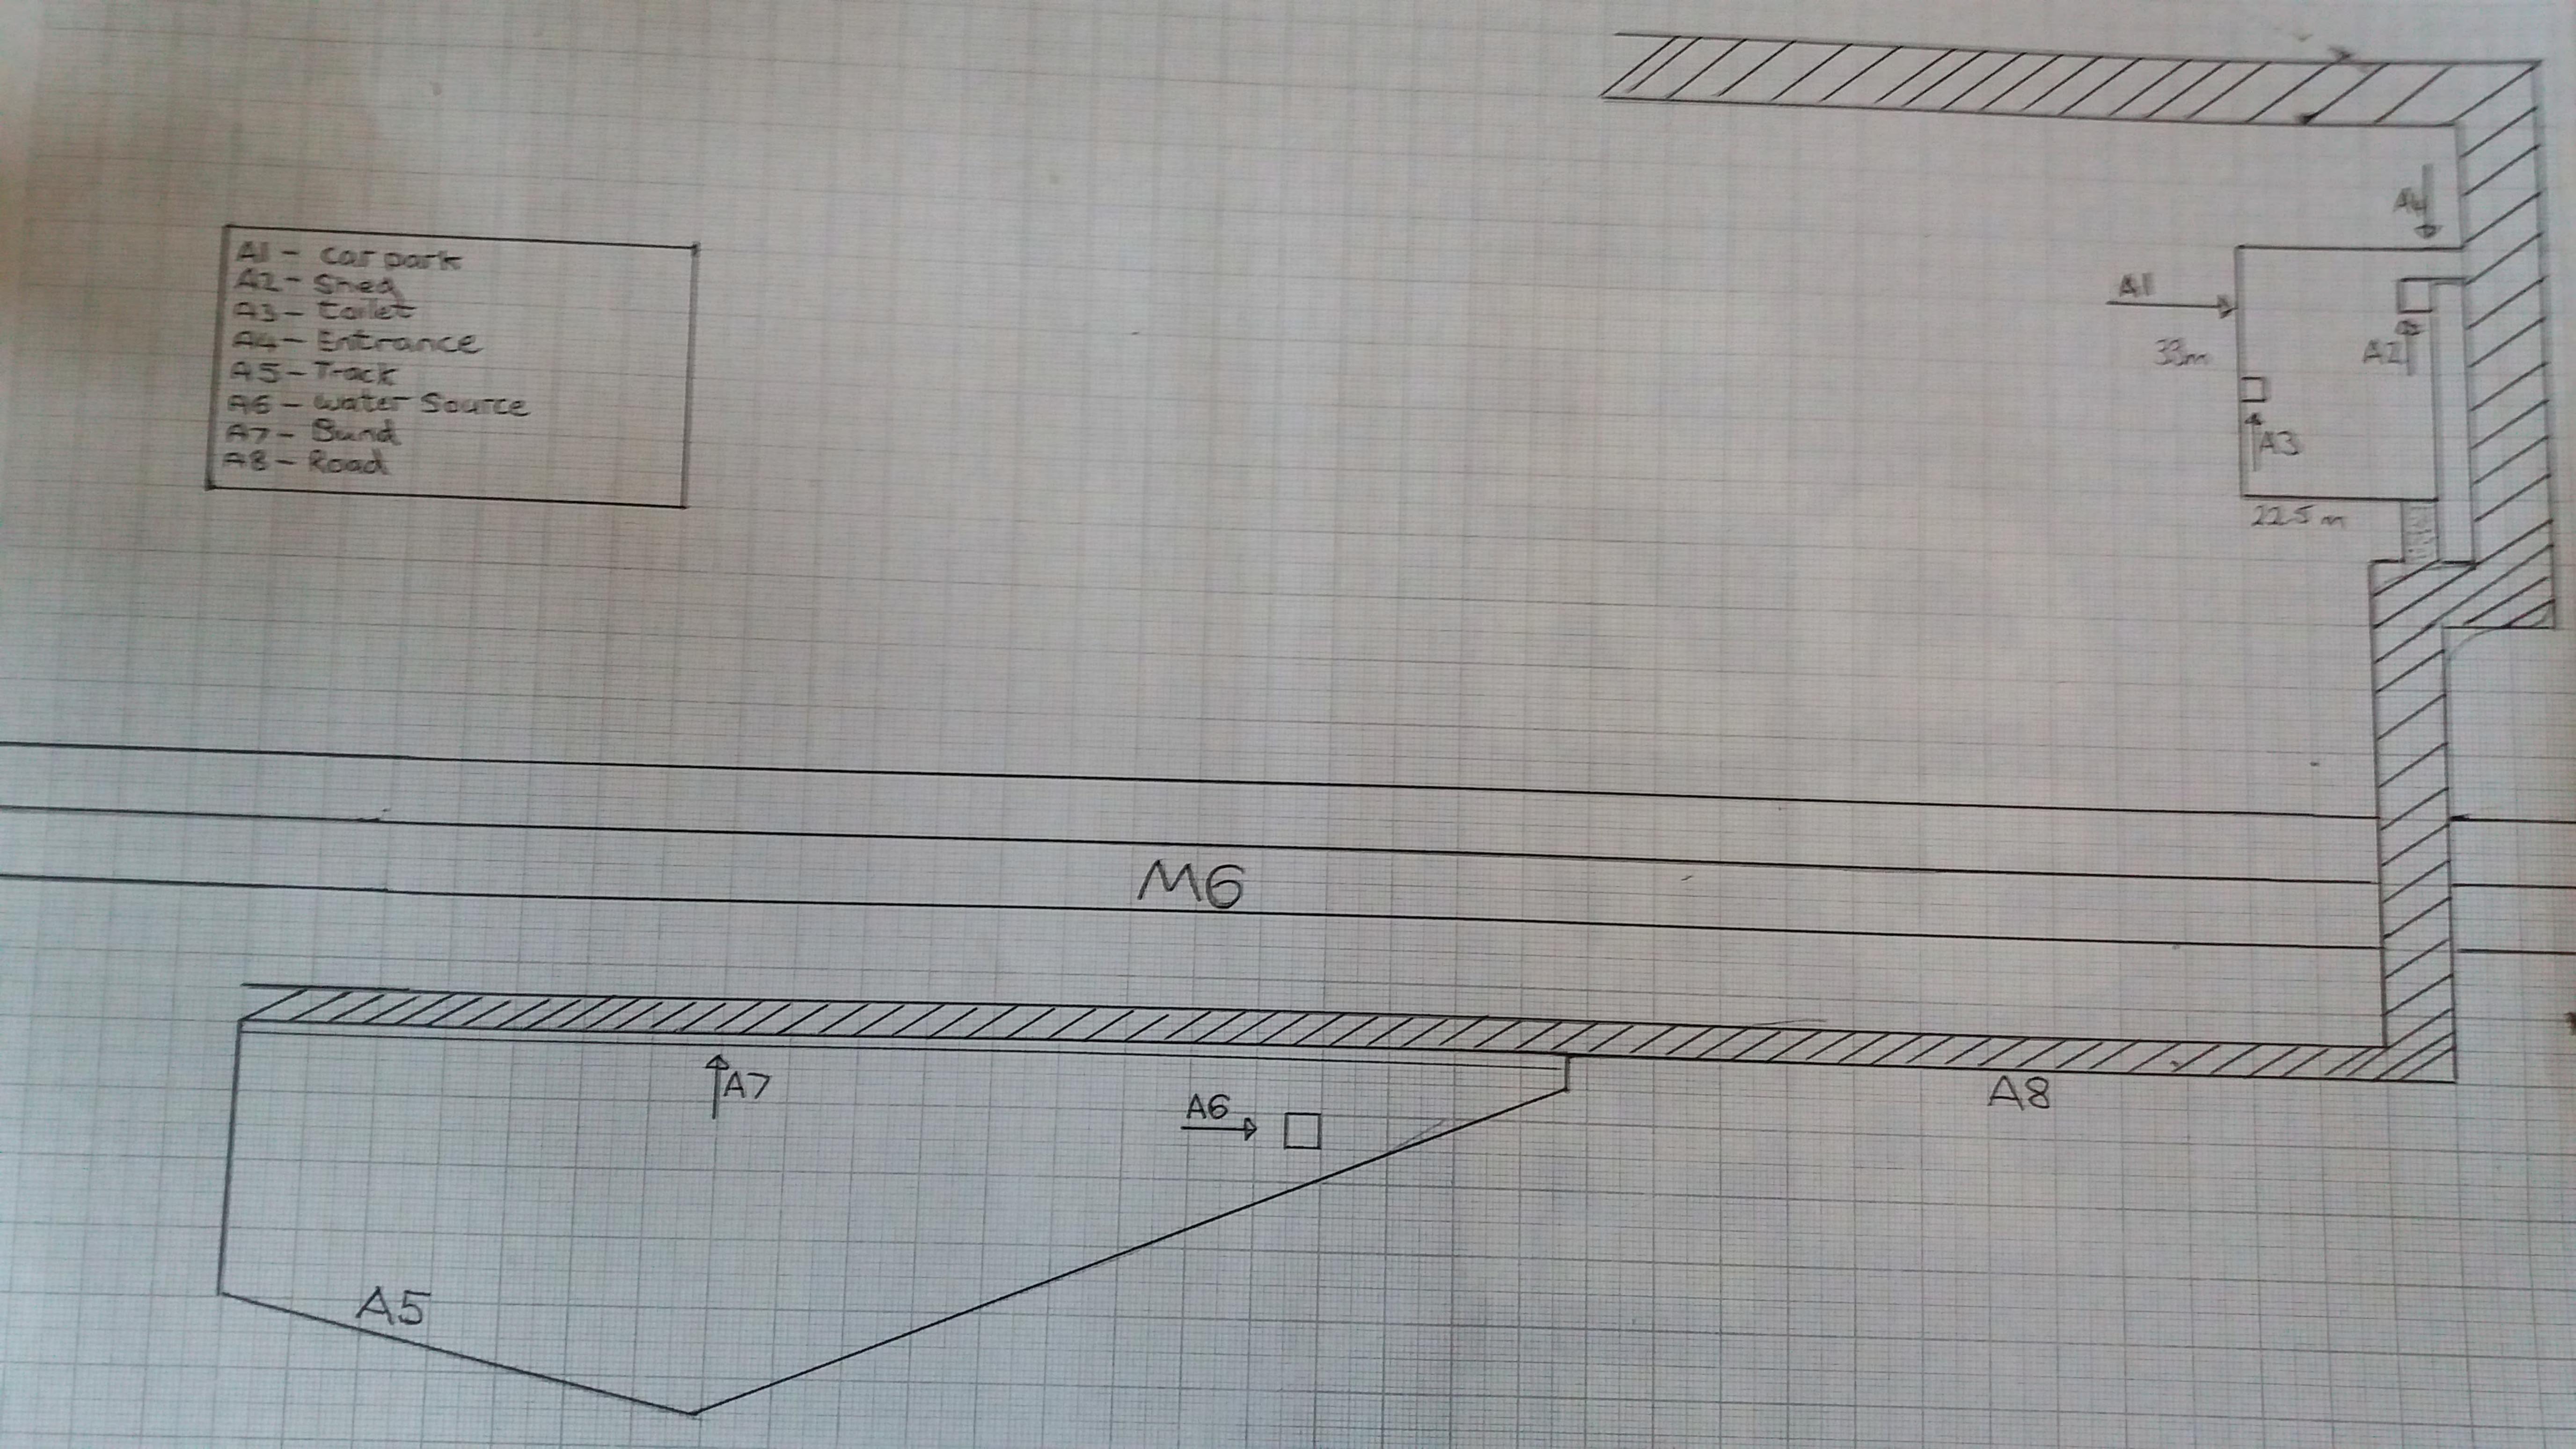


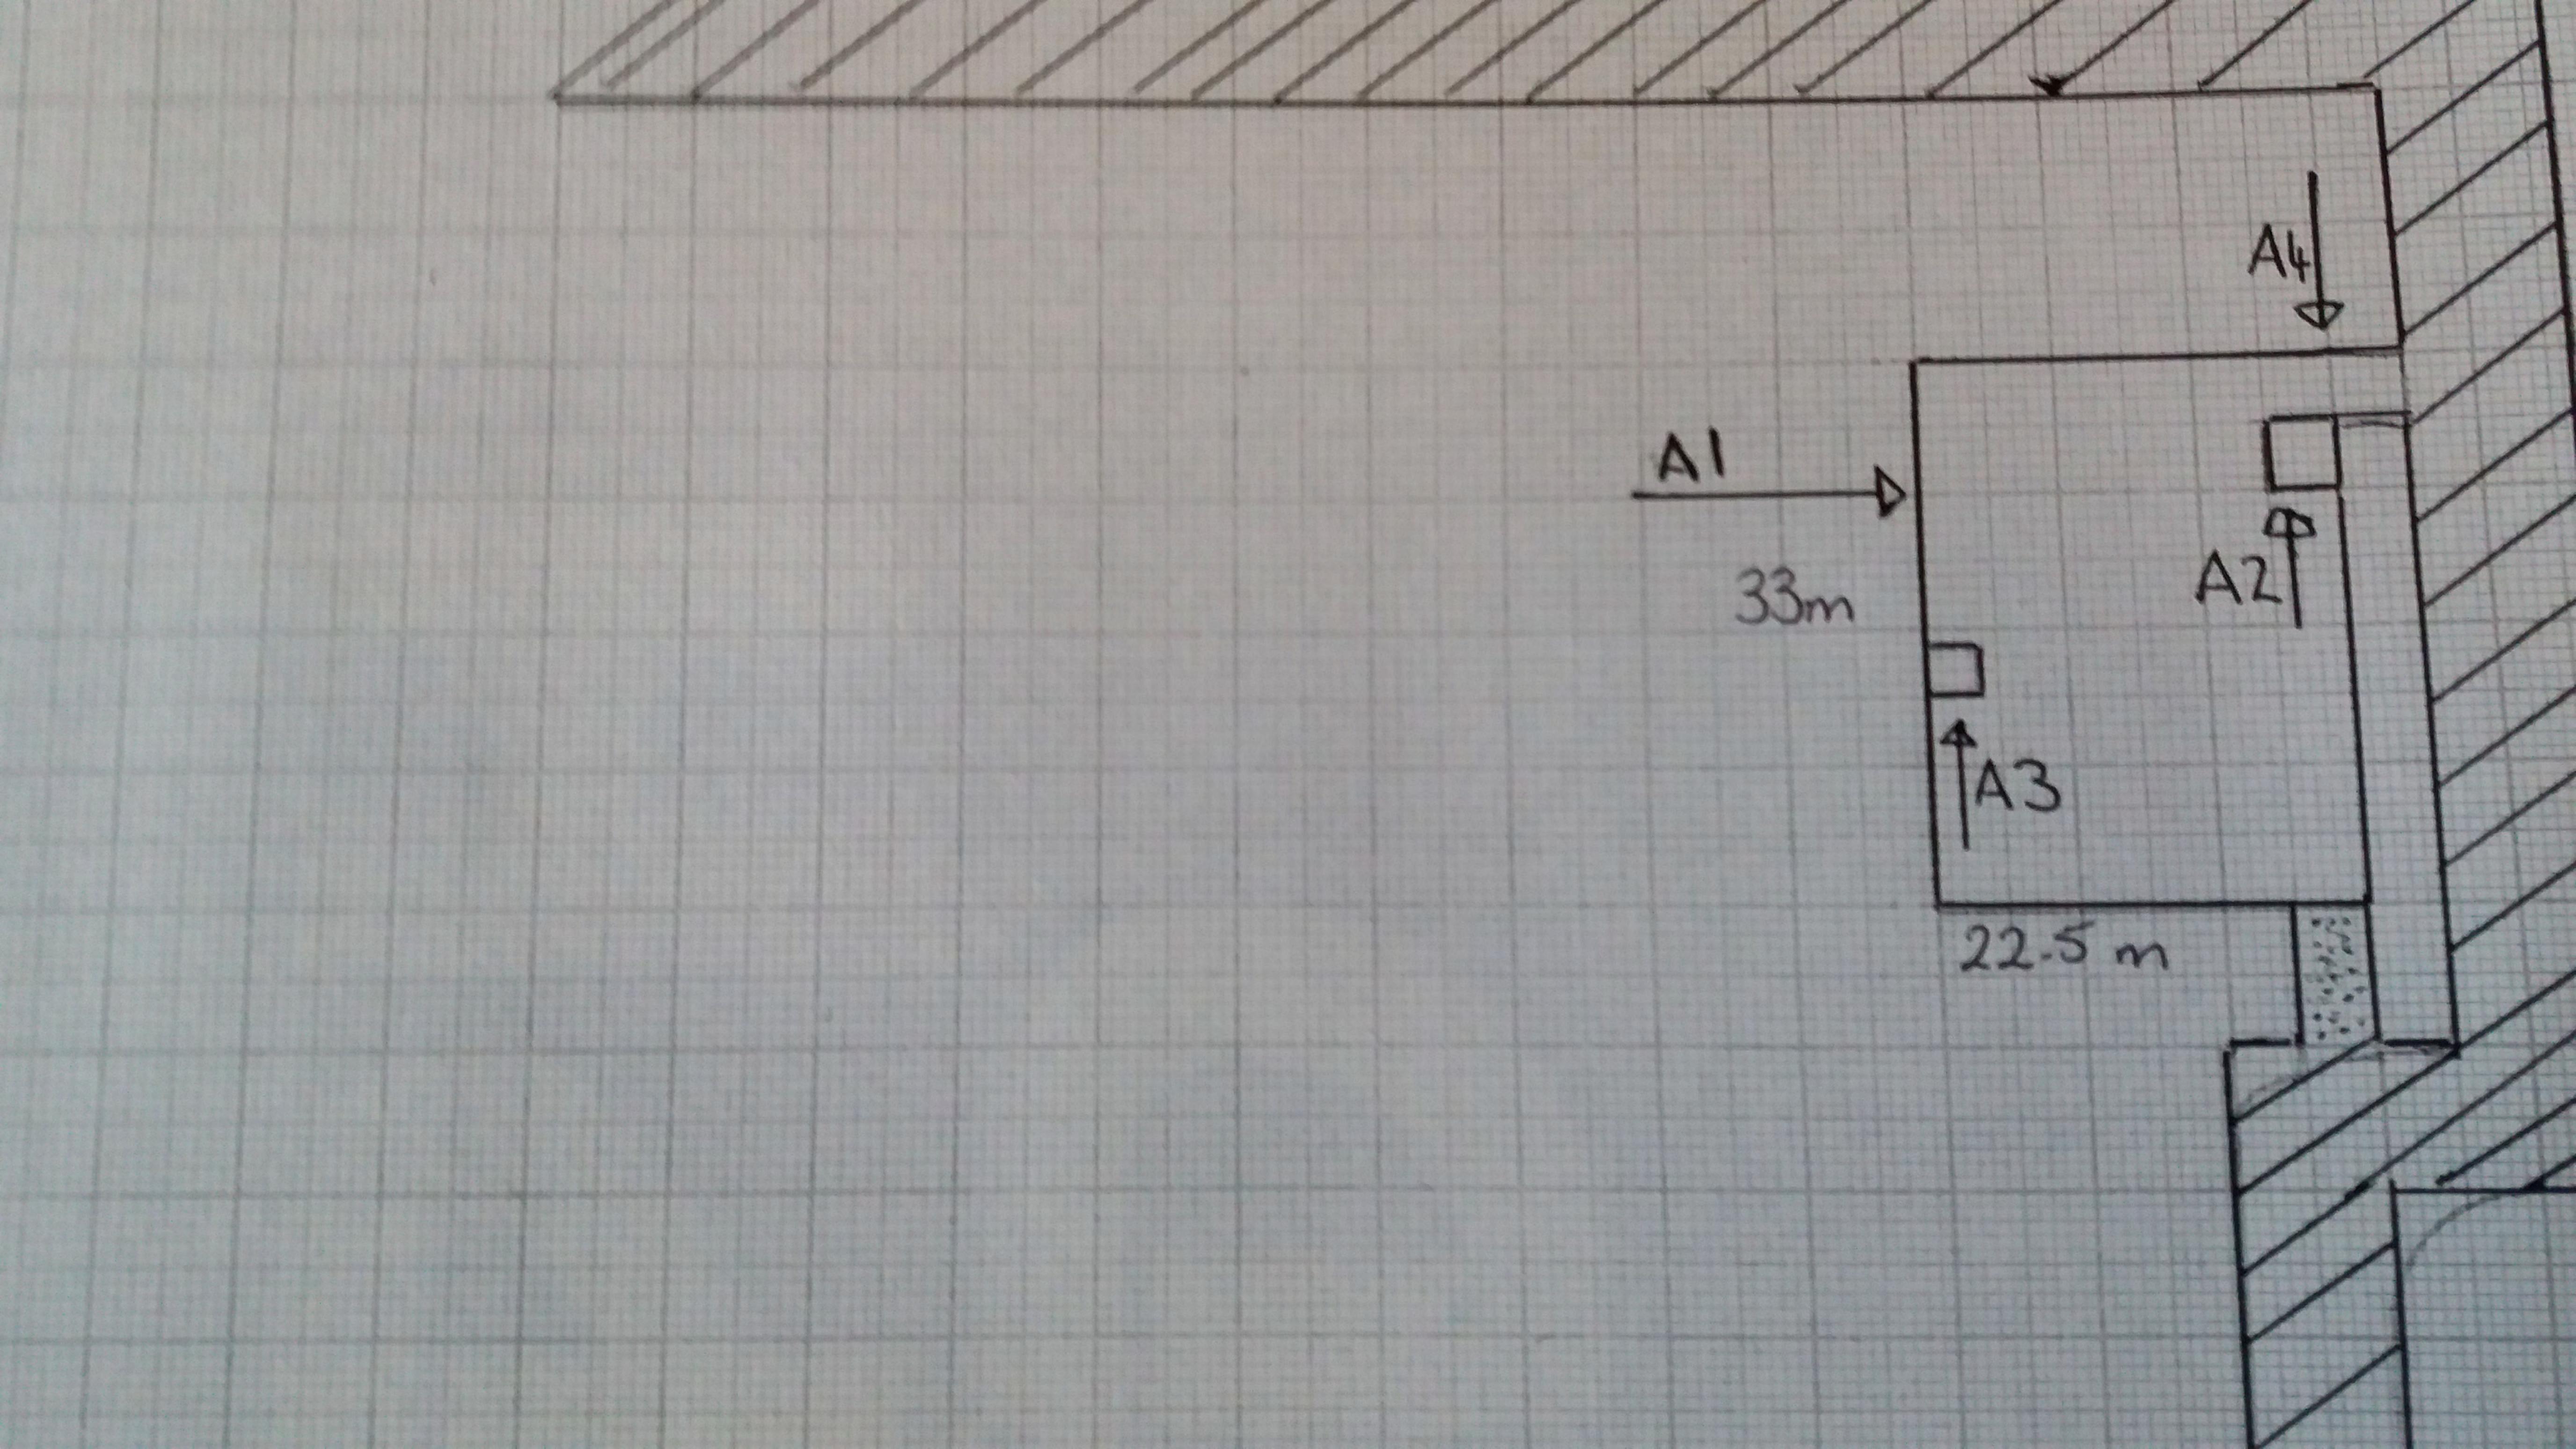


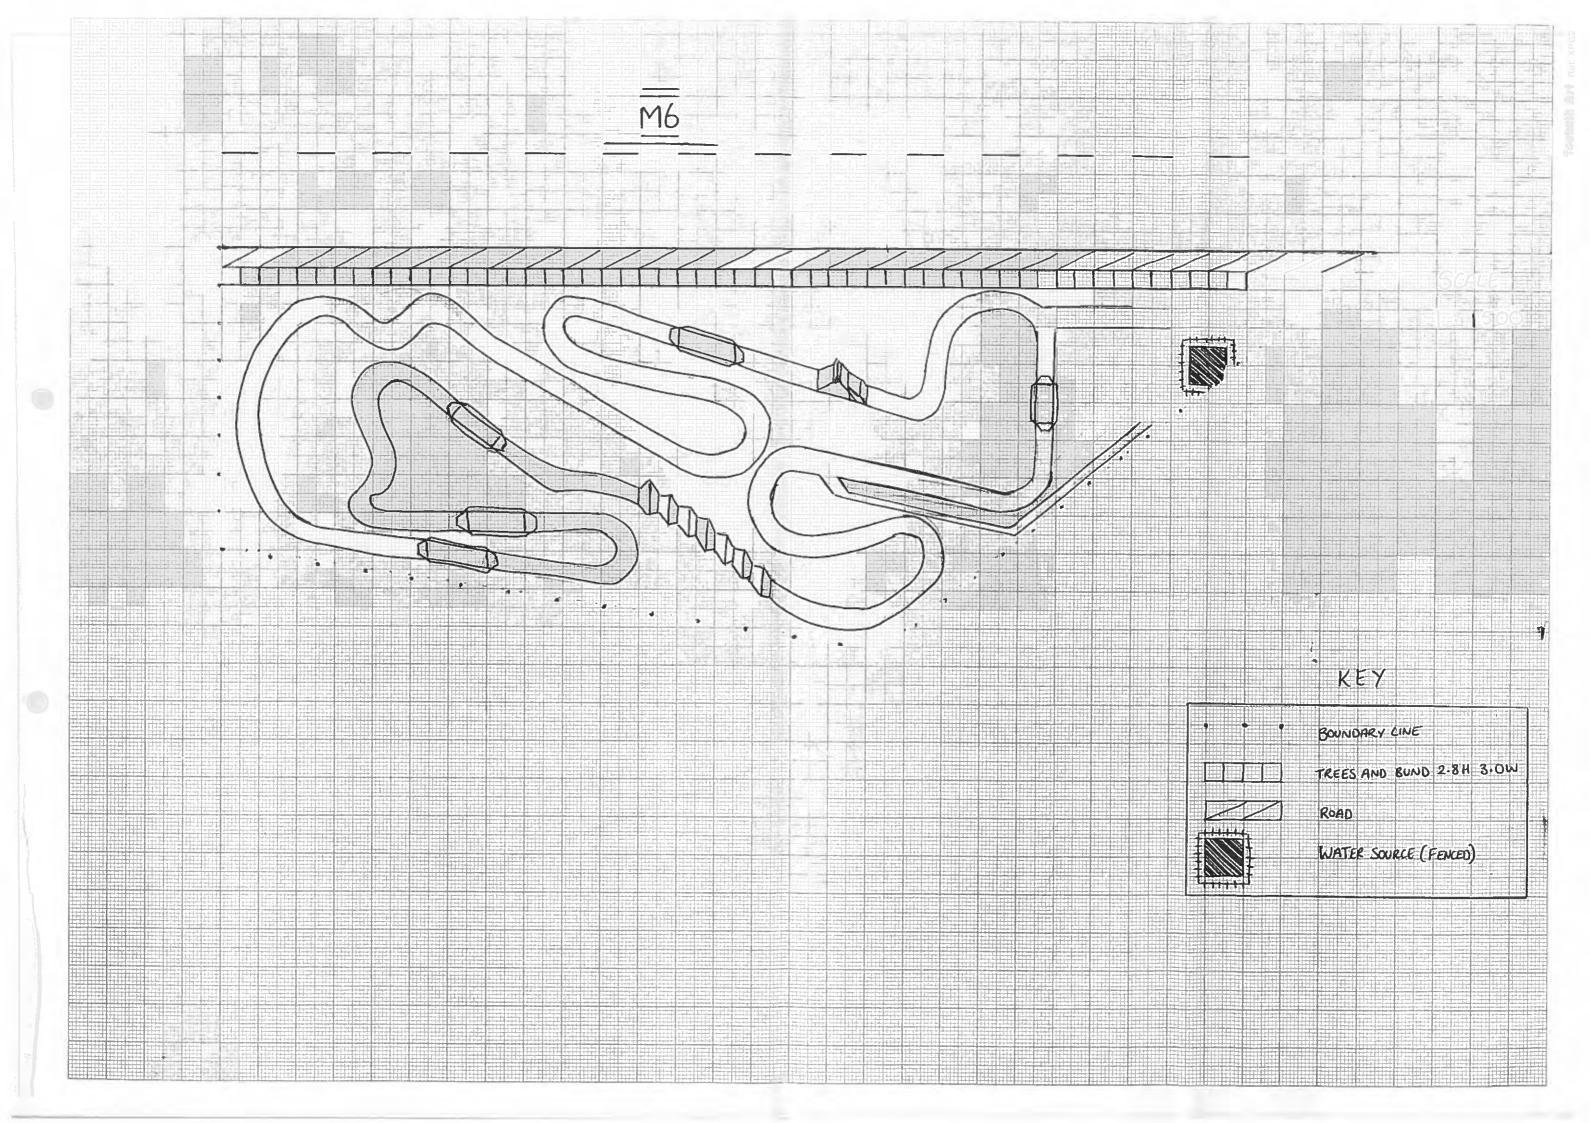


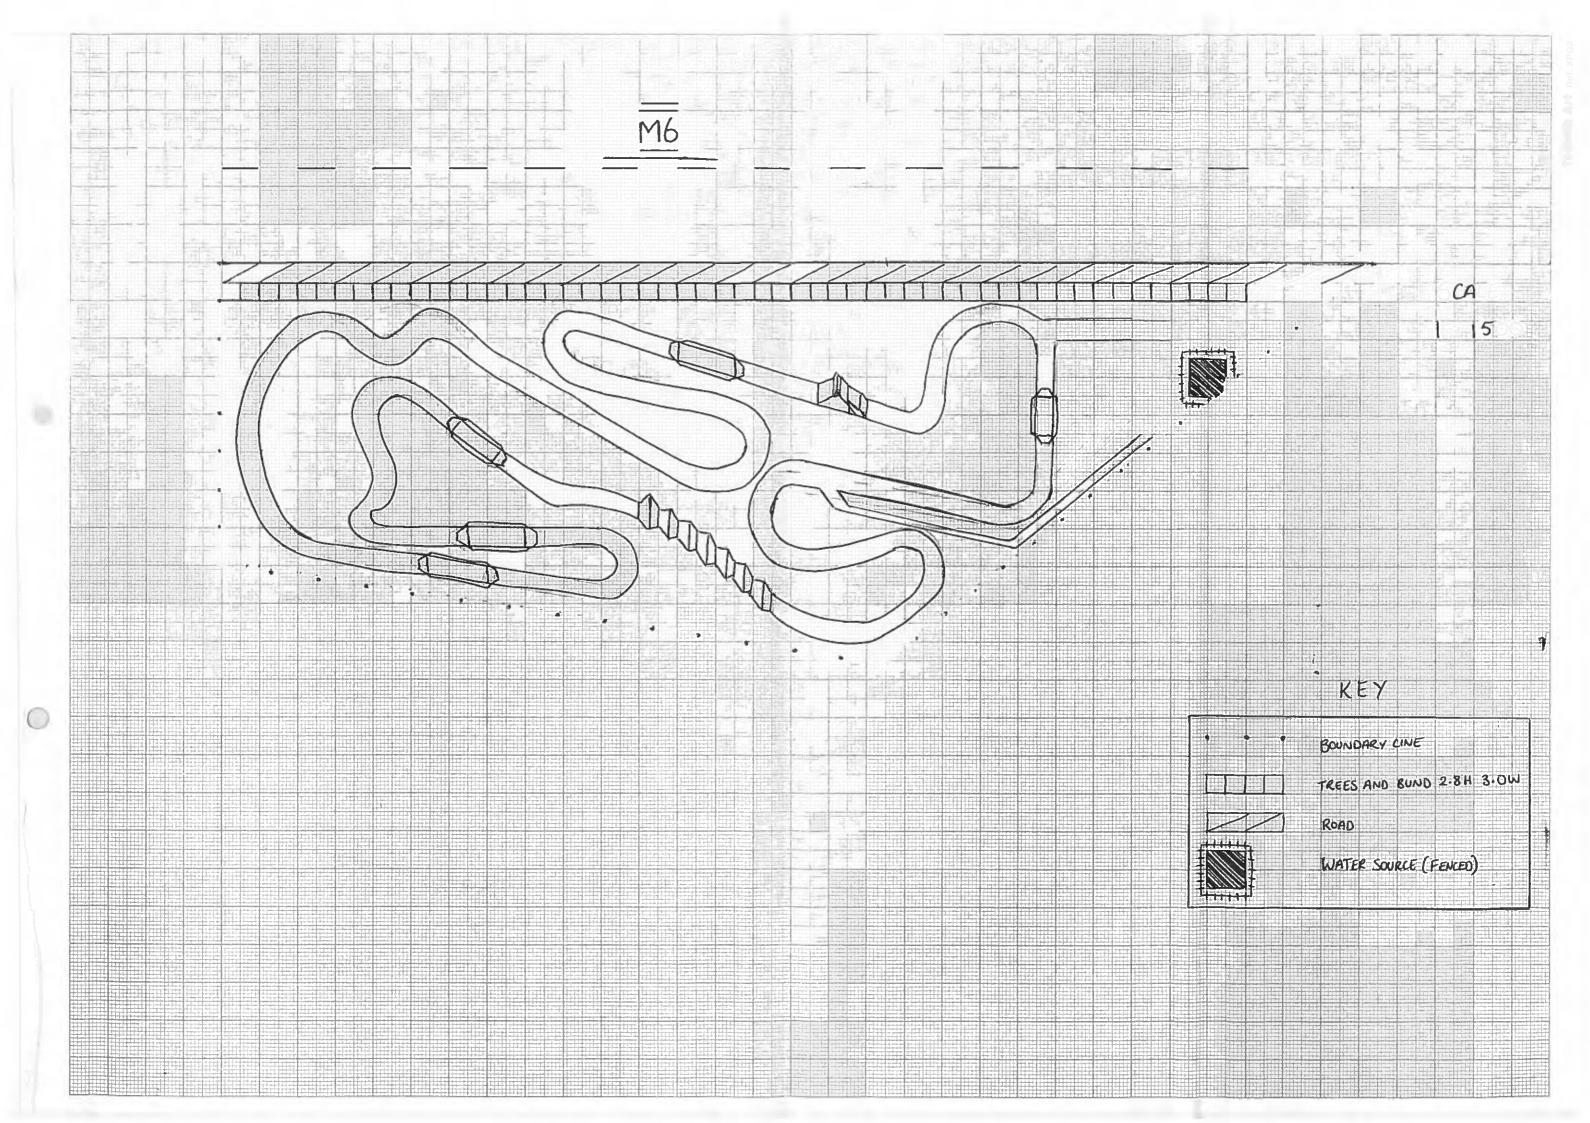

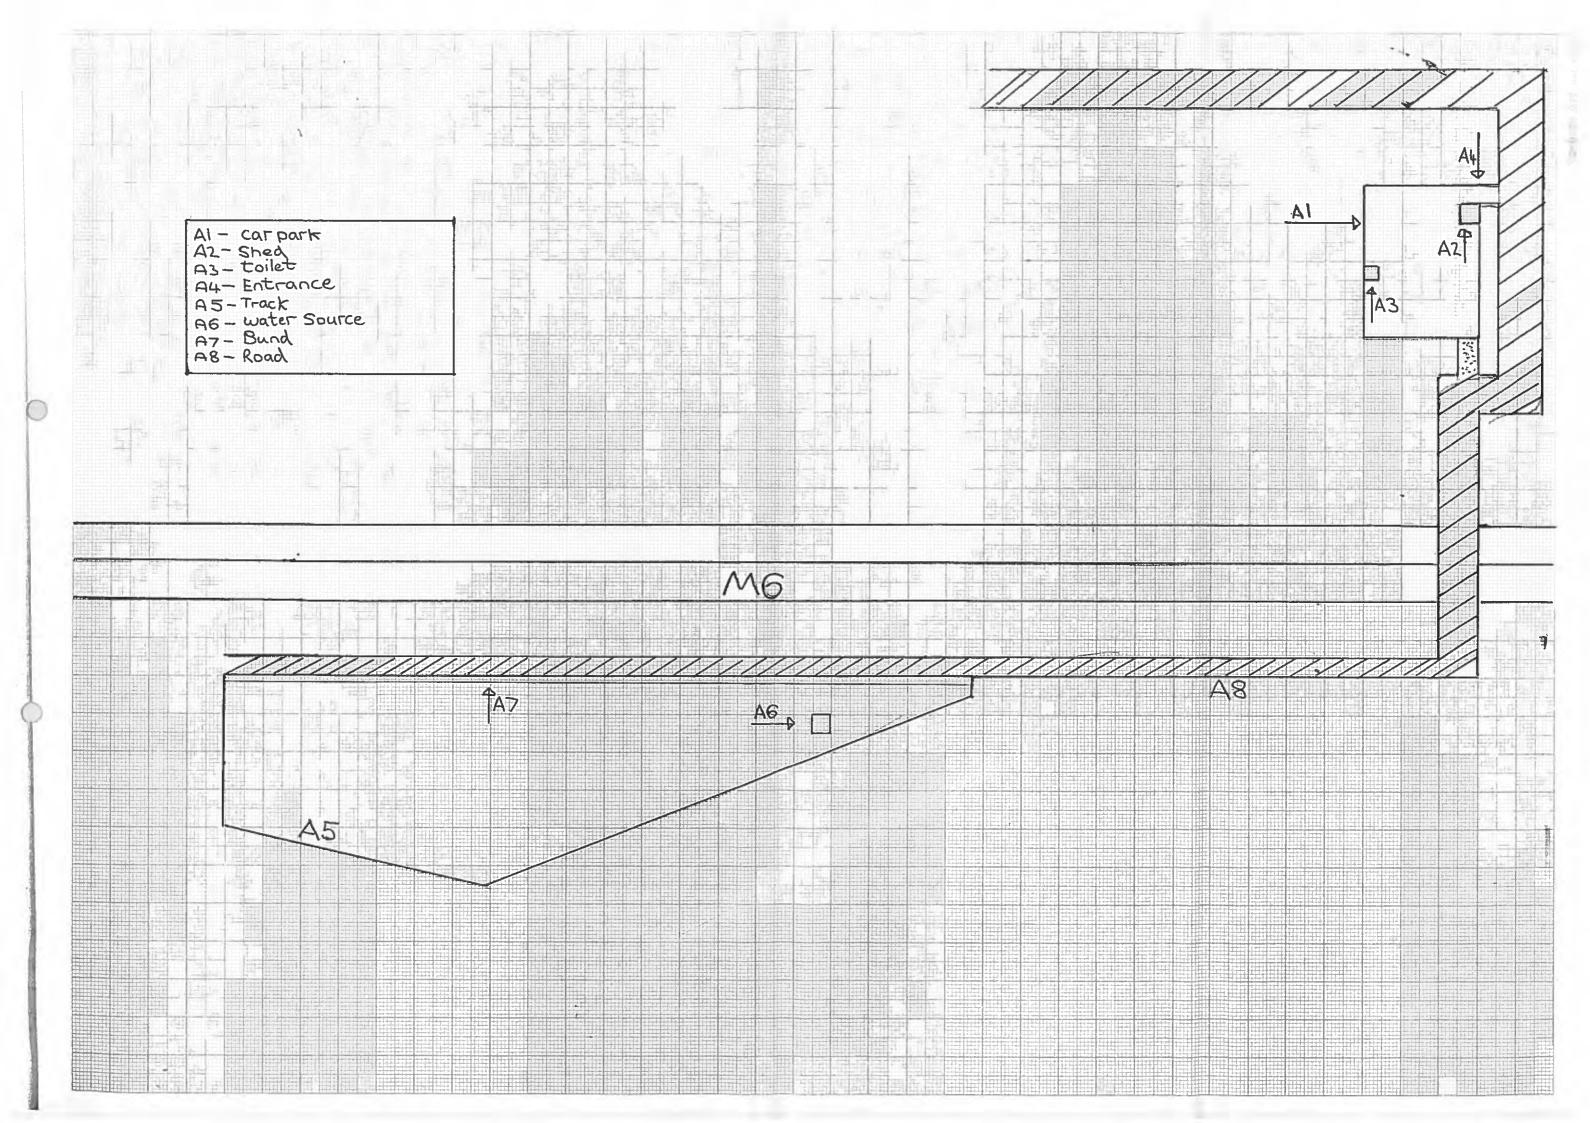

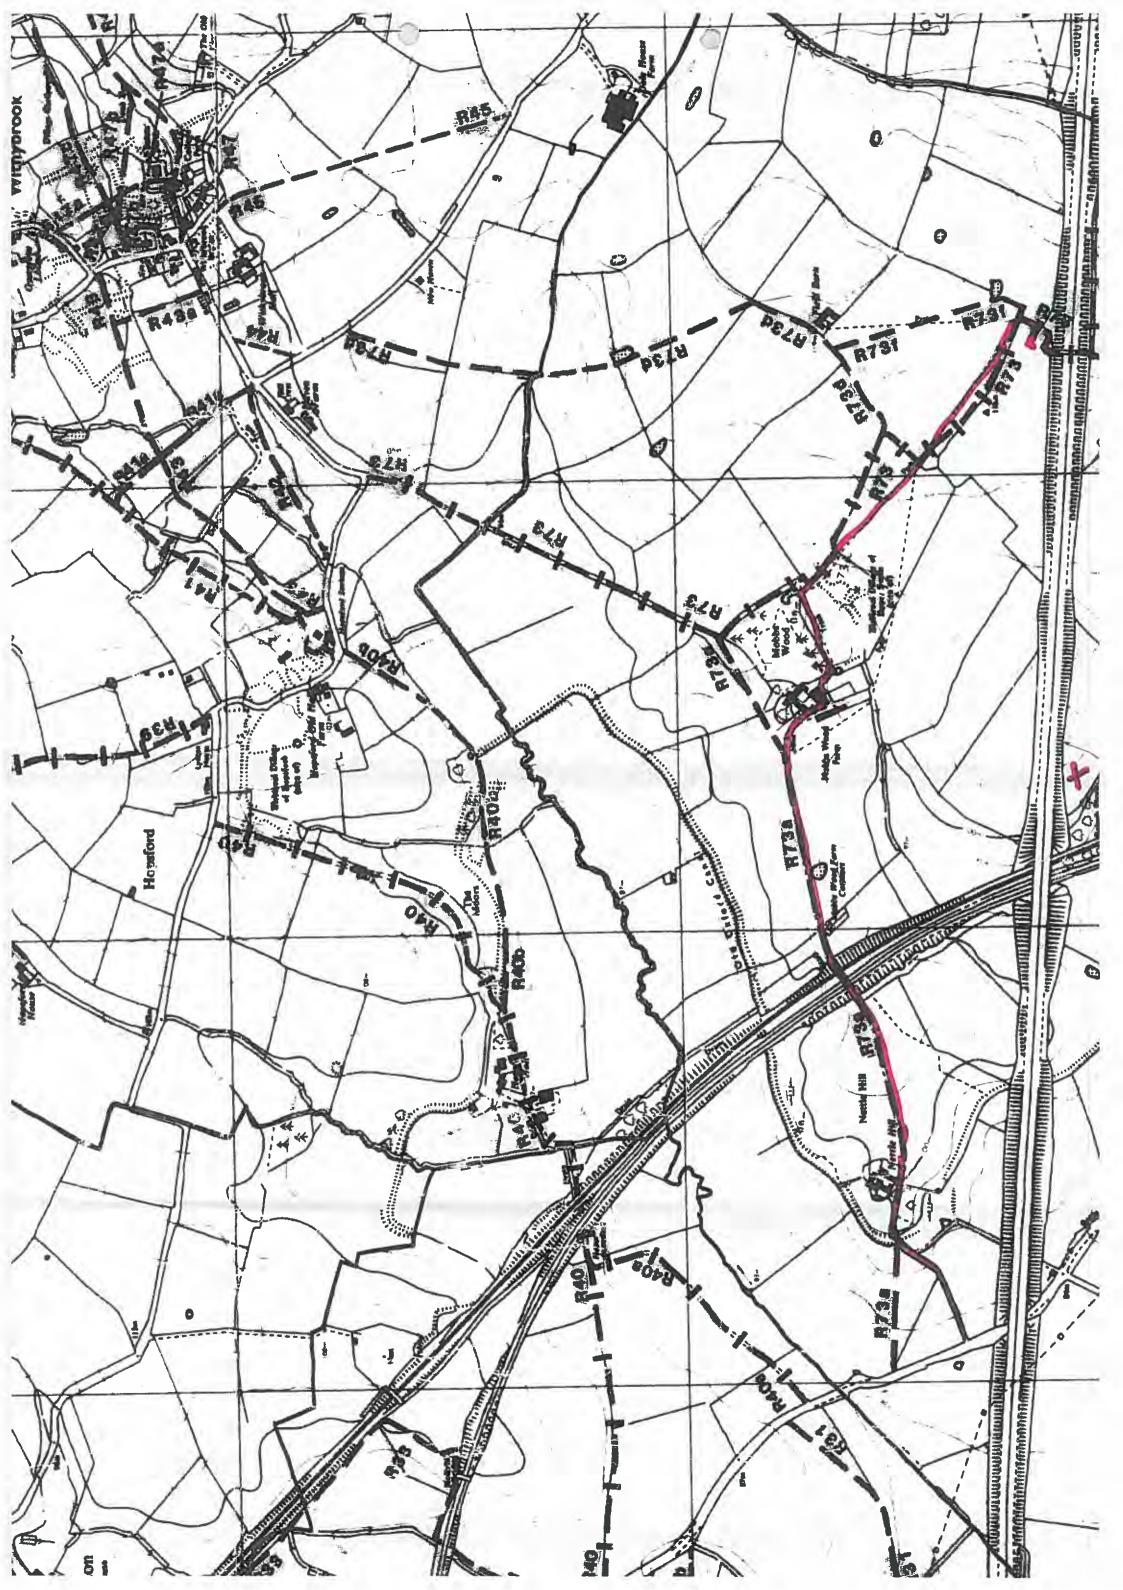

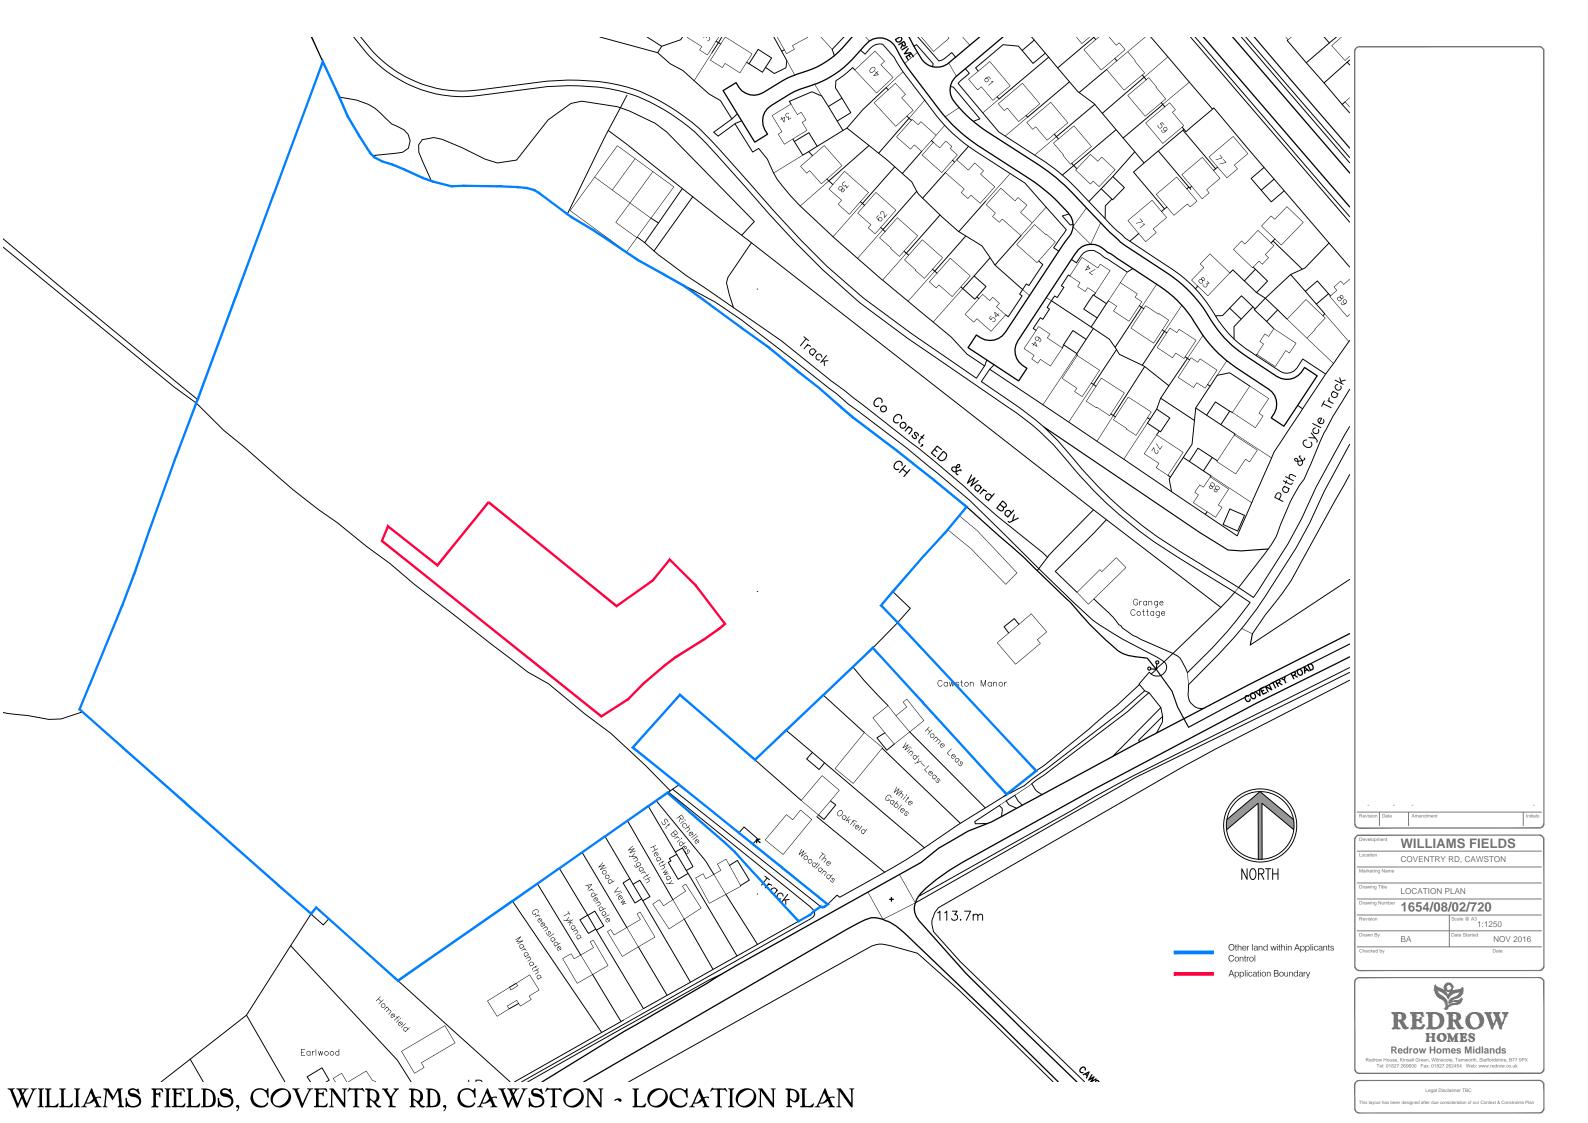

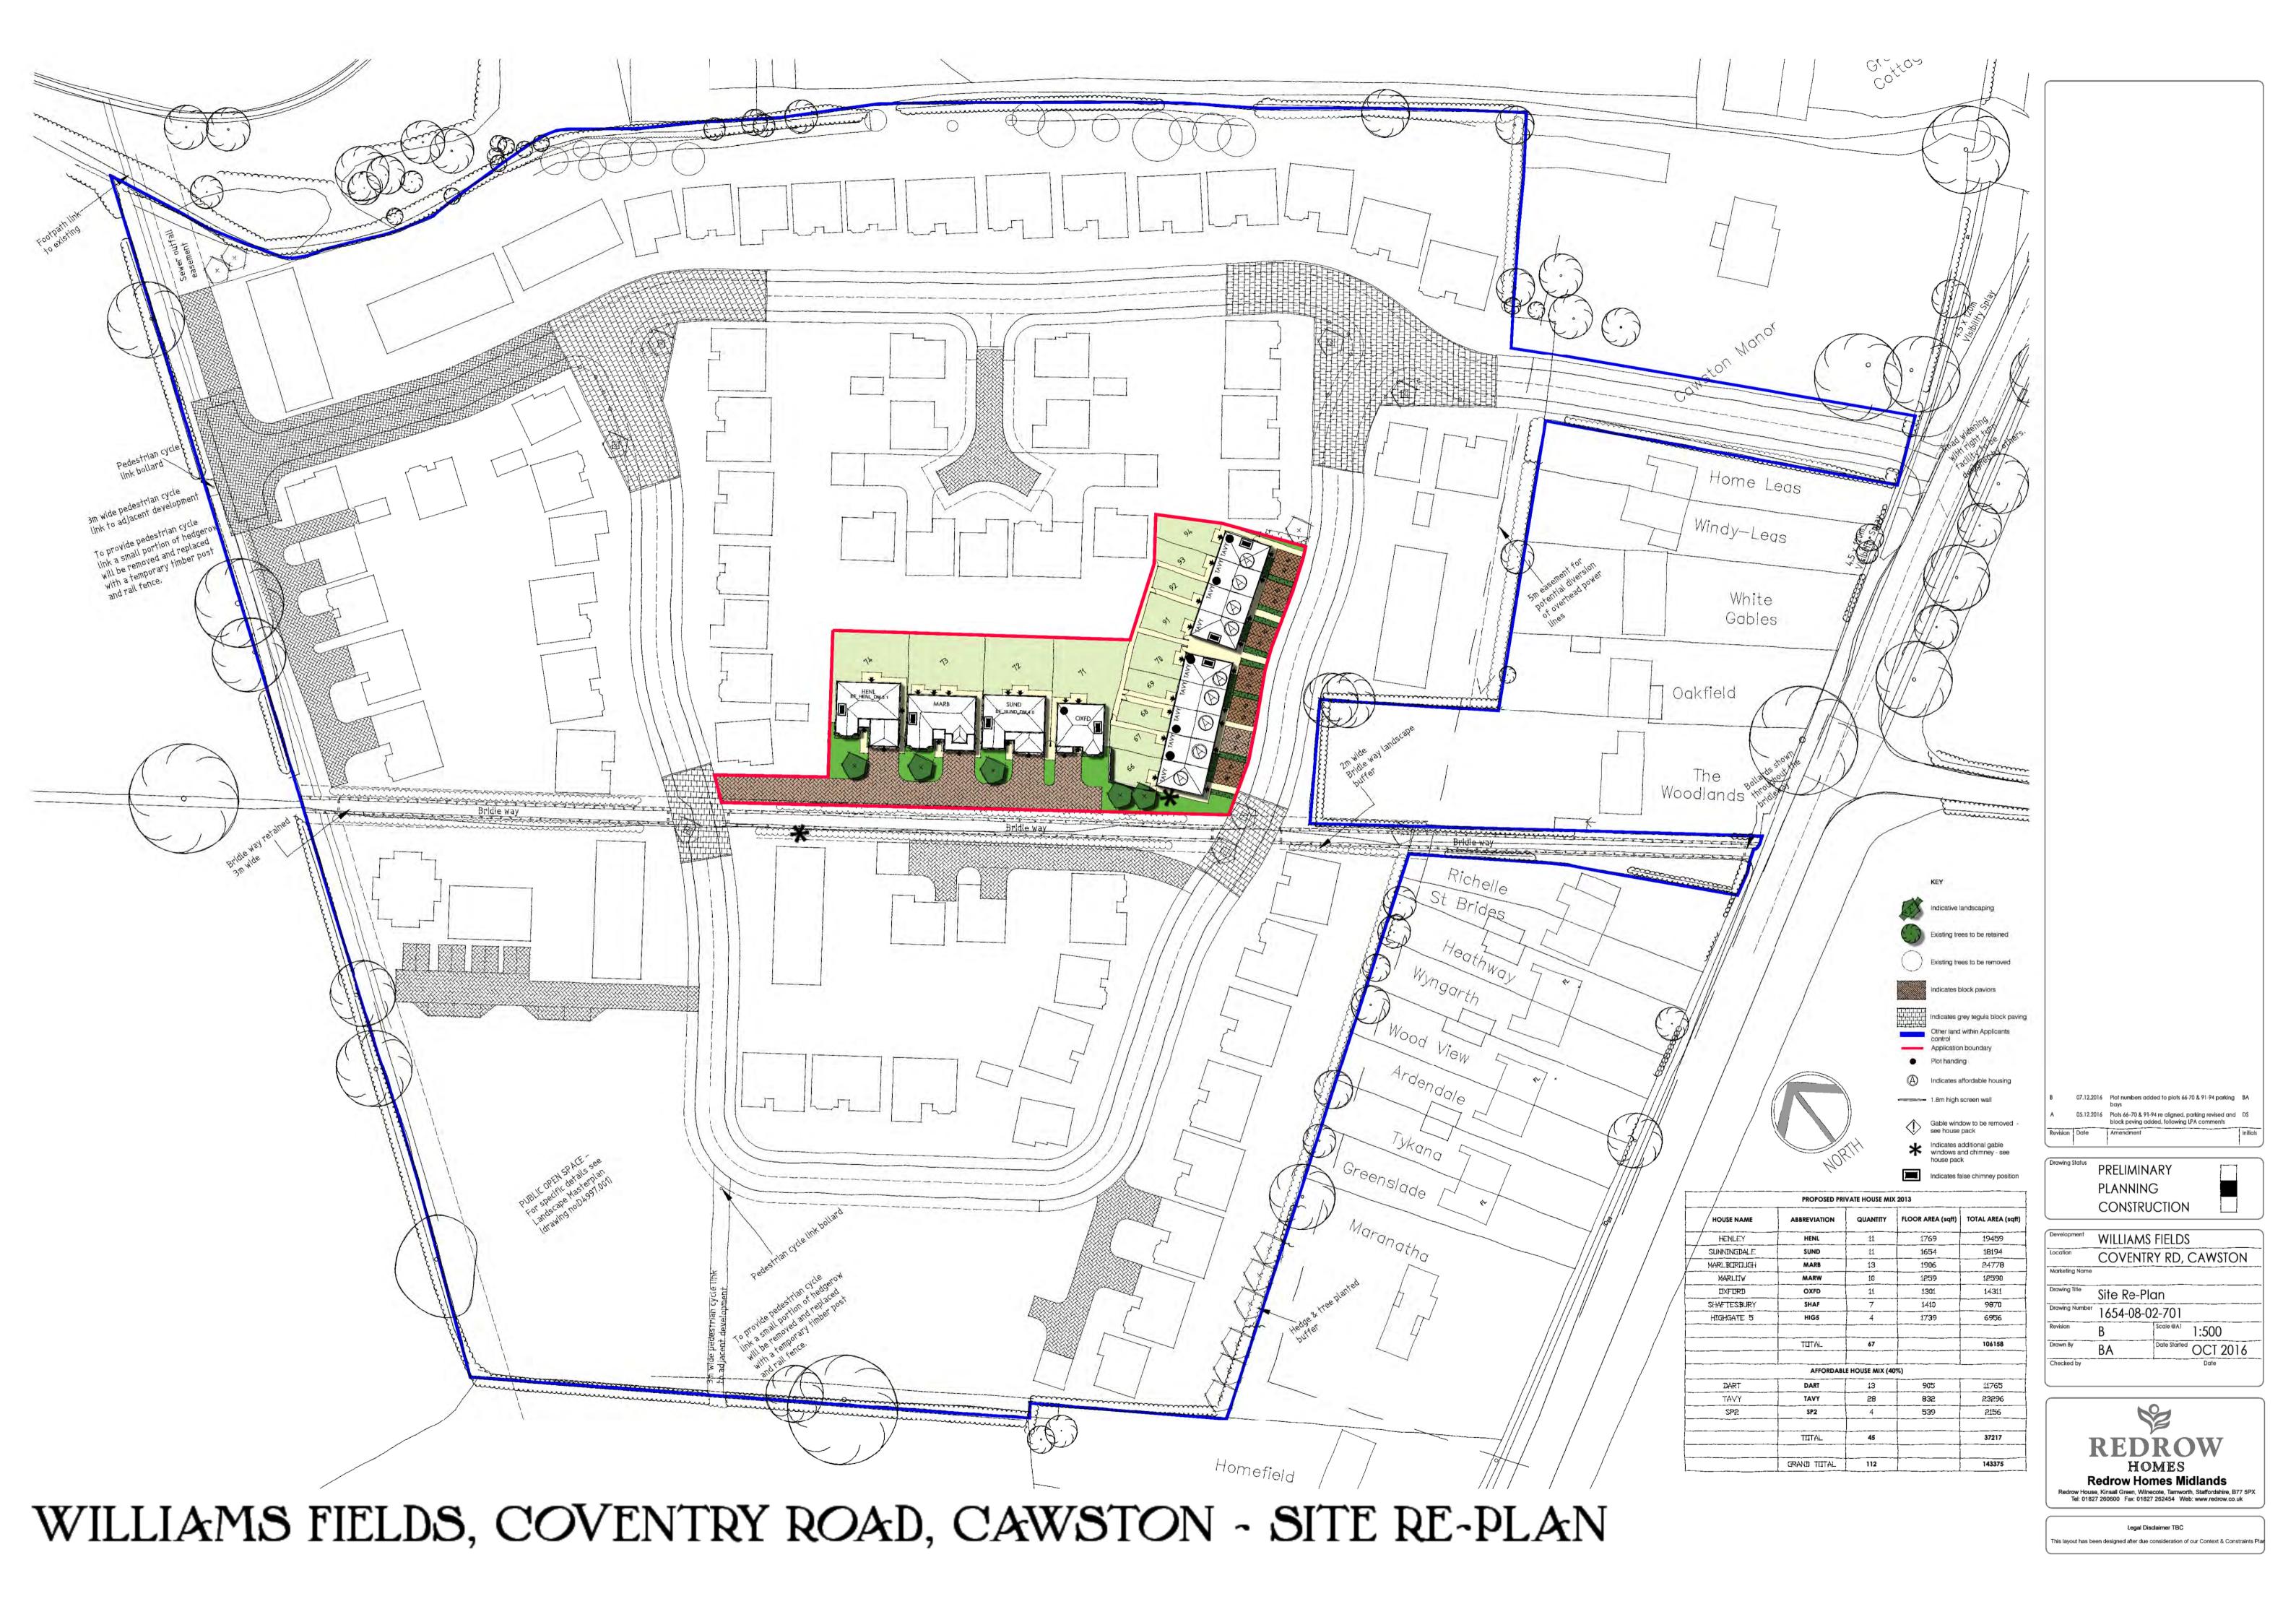





A 05.12.2016 Street Scenes amended to follow latest layout BA
Revision Date Amendment Initials

PRELIMINARY
PLANNING
CONSTRUCTION

Checked by

Development WILLIAMS FIEDS

Location COVENTRY ROAD CAWSTON

Marketing Name

Drawing Title STREET SCENES

Drawing Number 1654-08-02-712

Revision A Scale @A2 1:200

Drawn By HD Date Started OCT 2016



Legal Disclaimer TBC

This layout has been designed after due consideration of our Context & Constraints Pl

WILLIAMS FIELDS, COVENTRY ROAD CAWSTON -STREET SCENES

